Mintaro Hut

for Department of Conservation Project N°: 1772

yout ID	Layout Name	(Current Revision ID
01	Cover Sheet	Α	
02	Site Plan	D	ΦD.
03	Site Plan Stormwater & Sewer	В	QD
04	Floor Plan	С	
05	Foundation Plan Hut	D	Φ
06	Foundation Plan Deck	С	dD.
07	Setout and Framing Plan	D	dD.
08	Deck Setout Plan	В	
09	Bracing Plan	В	
10	Roof Framing Plan	В	
11	Roof Plan	В	
12	Plumbing Gas and Drainage Plan	Α	
13	Electrical Plan	В	
14	Elevations	Е	ΔD
15	Elevations	D	
16	Section A	D	
17	Section A	Е	QD
18	Section B	D	-
19	Section C	Е	dD.
20	Window and Door Schedule	В	
21	Window and Door Schedule	Α	
22	Window Details	Α	
23	Louvre Details Gables	Α	
24	Louvre Details Walls	Α	
25	Roof Details Seating and Cooking Area	Α	
26	Roof Details Seating and Cooking Area	Α	
27	Roof Details Bunkroom Area	Α	
28	Roof Details Deck	Α	
29	Roof Details	Α	
30	Wall Details	Α	
31	Fire-Rated Door Details	Α	
32	Fire-Rated Details	Α	
33	Corridor Floor Details	Α	
34	Deck / Floor Edge Details	Α	
35	Deck Details	В	
36	Deck and Stair Details	В	
37	Post Connections	A	
38	Terraced Steps Details	В	
39	Individual Bunk Type 1 and 2	A	
40	Individual Bunk Type 3	Α	
41	Individual Bunk Details	Α	
42	Floor Vents	Α	
43	Fixed Seating Pack Rack Coat Hooks Details	Α	
44	Cooking Area Details	Α	
45	Tables and Forms	Α	
46	Woodburner Drying Rack Boot Lockers	В	
47	Water Tank Stand	В	
48	Gas Bottle Storage	 B	
49	North Wall Framing	В	QD.
50	Portal Bracket	A	~
51	North Deck Beam Elevation / Section	В	dD.
60	3D Interiors	D	QD
61	3D Exteriors	D	QD

Detailed Design September 2019




DESIGN CRITERIA:	
Soil Type: Exposure Zone: Wind Zone: Earthquake Zone: Floor Load (Hut): Floor Load (Decks): Altitude: Snow Load:	D B Very High 4 3.0 kPa 2.0 kPa 620m 2.0 kPa







WELLINGTON 76-86 Manners Street, Wellington 6011 PO Box 2115, Wellington 6140. **+64 4 473 7577**

CHRISTCHURCH
1/24 Gasson Street, Sydenham, Christchurch 8023
PO Box 12014, Beckenham, Christchurch 8242. +64 3 550 0575
www.pc-architects.co.nz

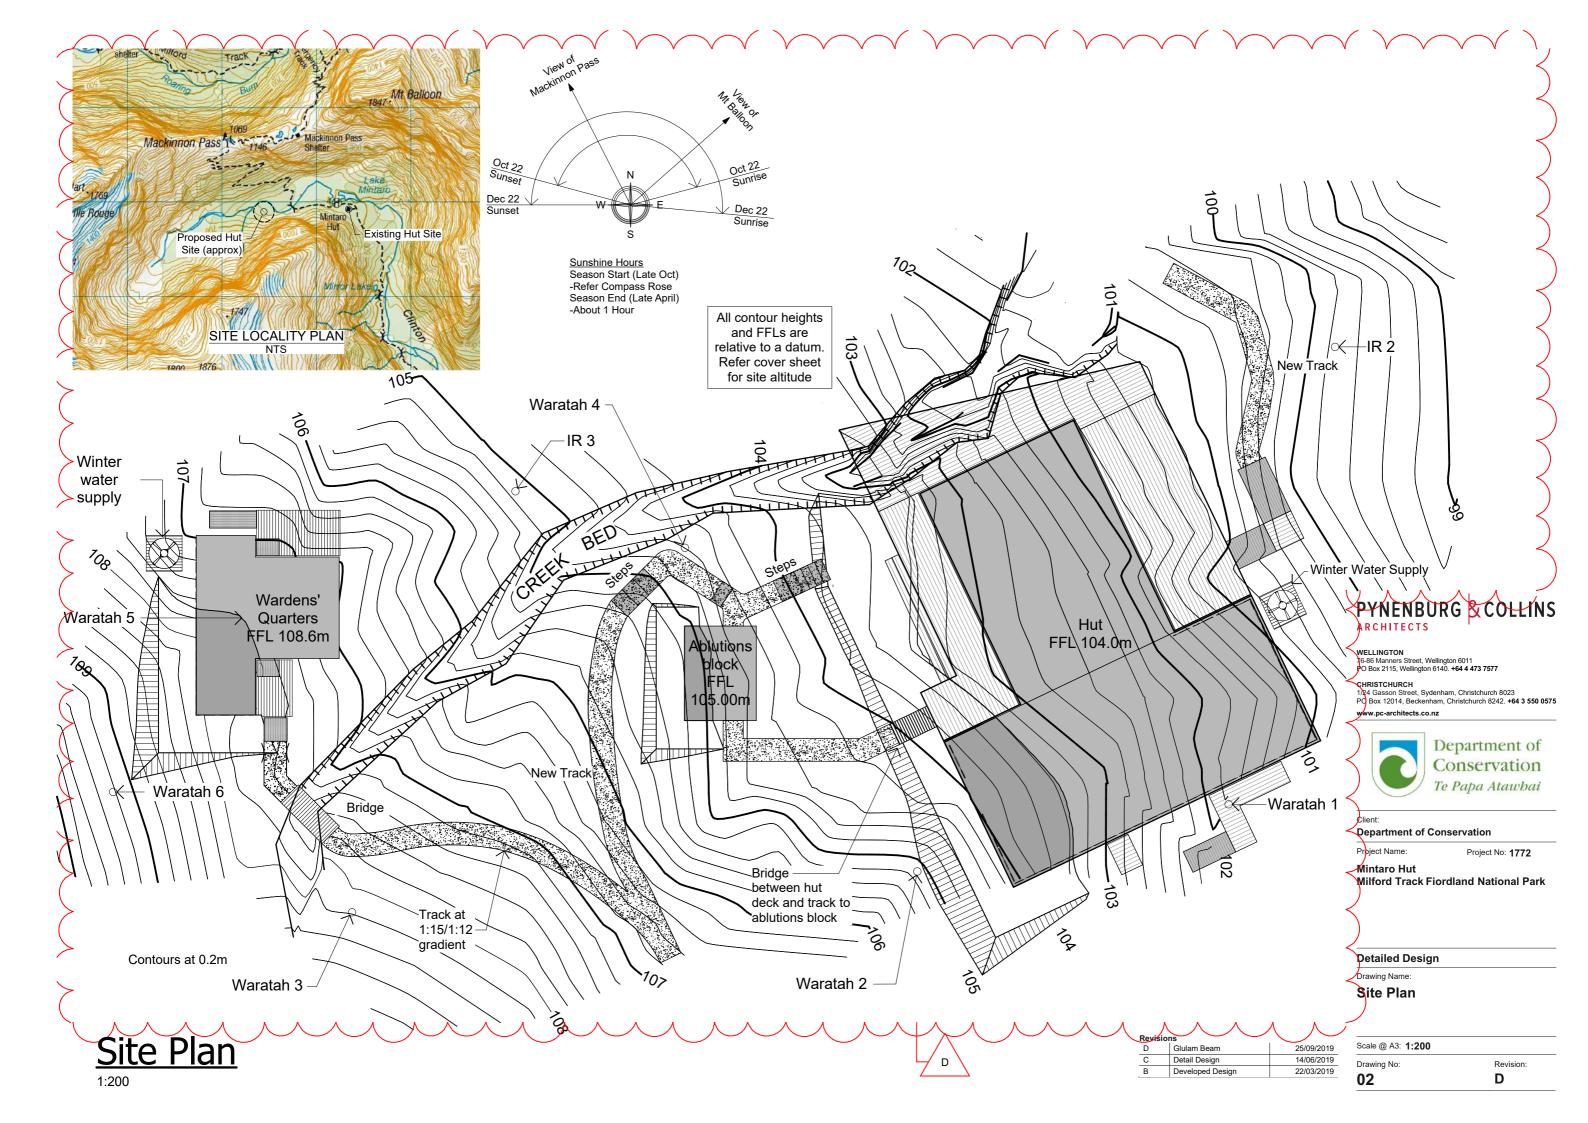

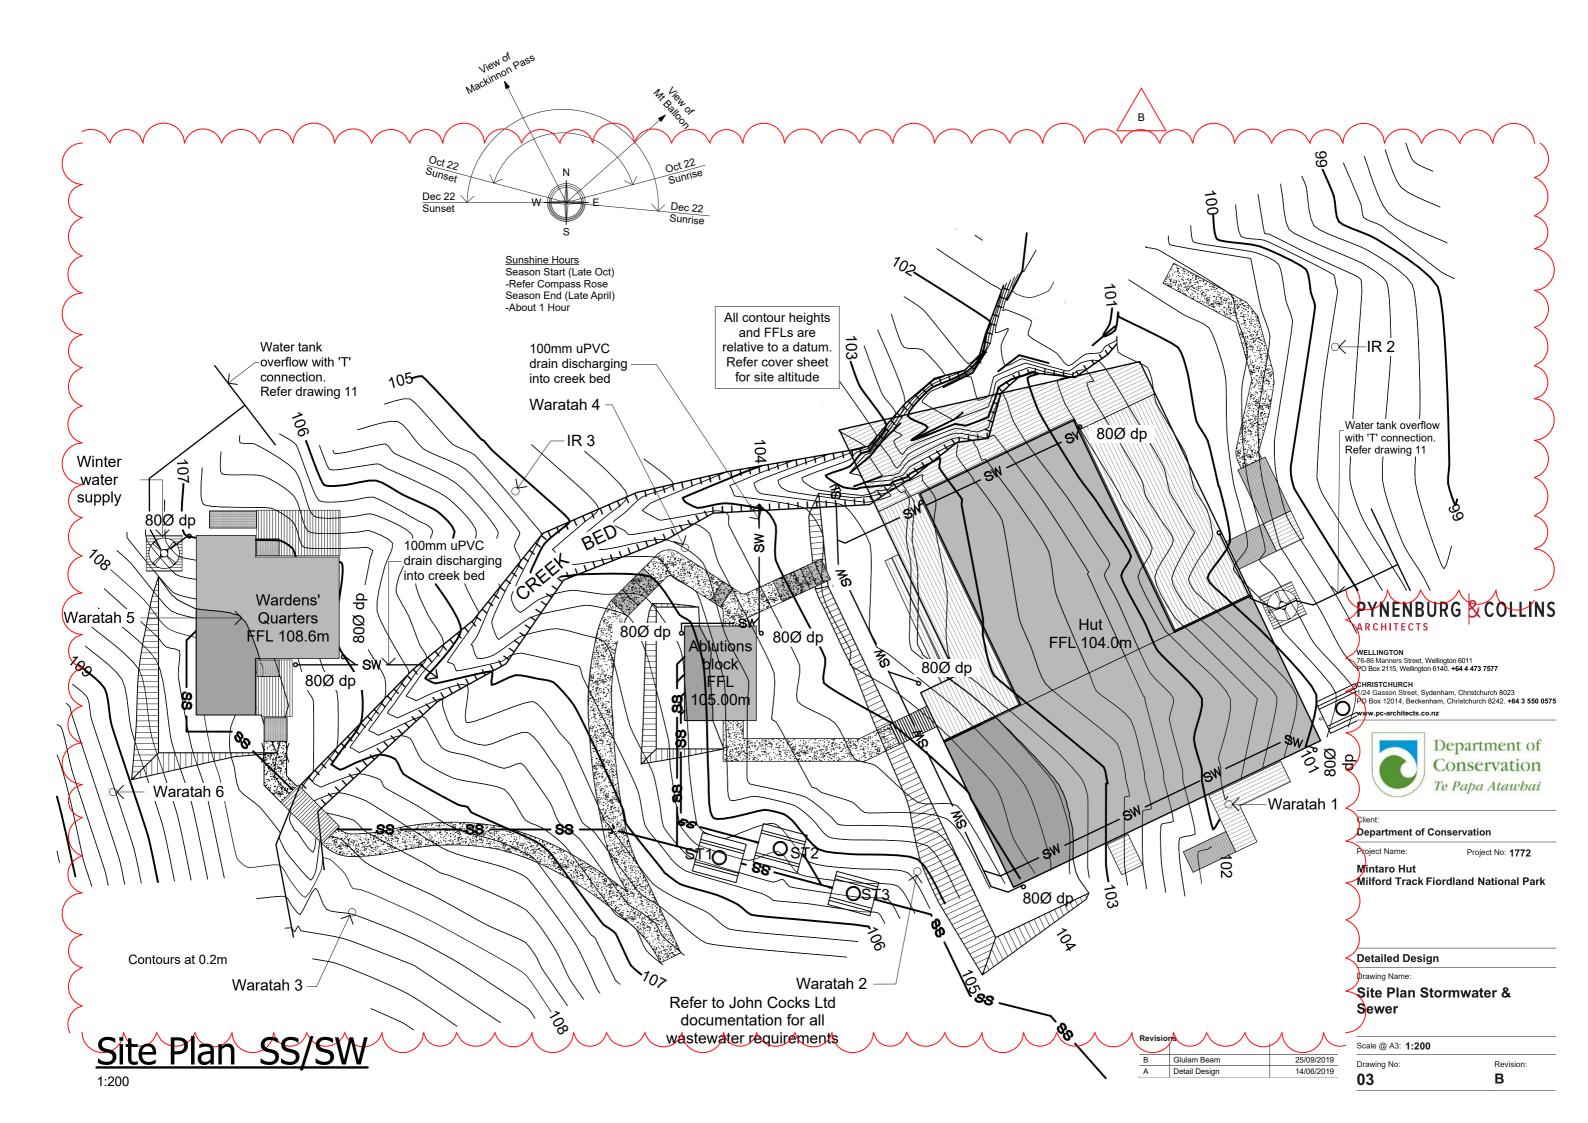

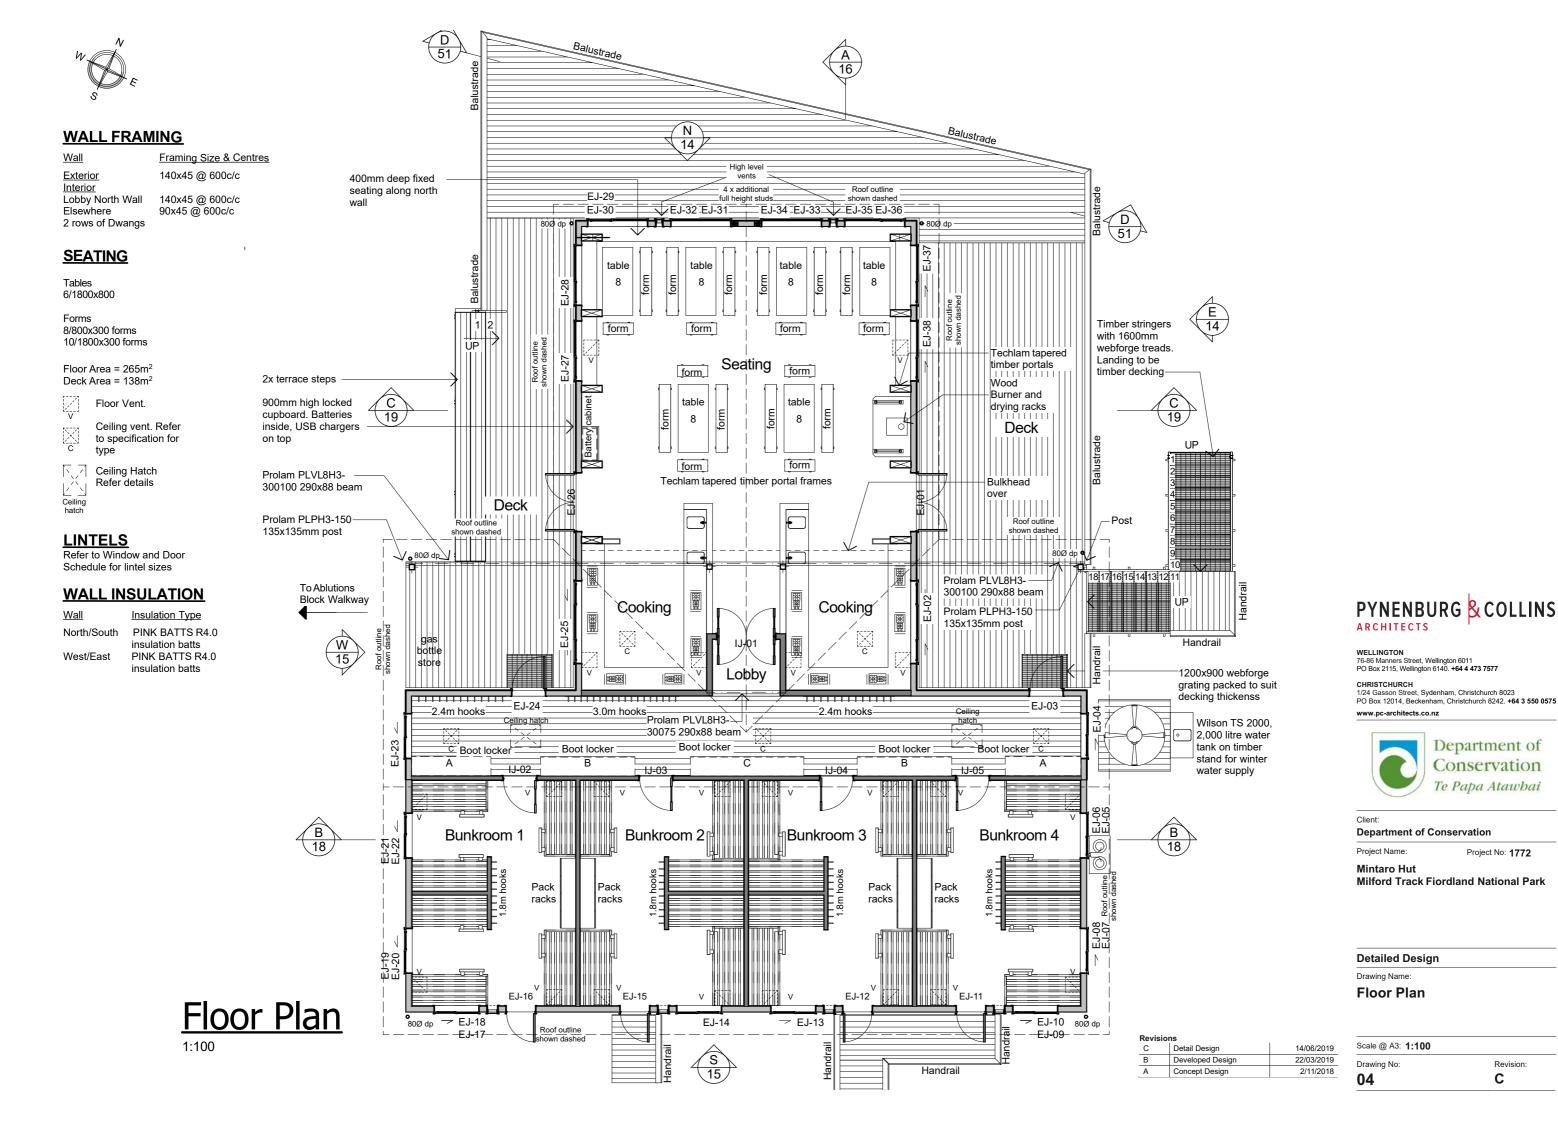

Department of


Conservation


Te Papa Atawbai


Project No: 1772


Revision


C

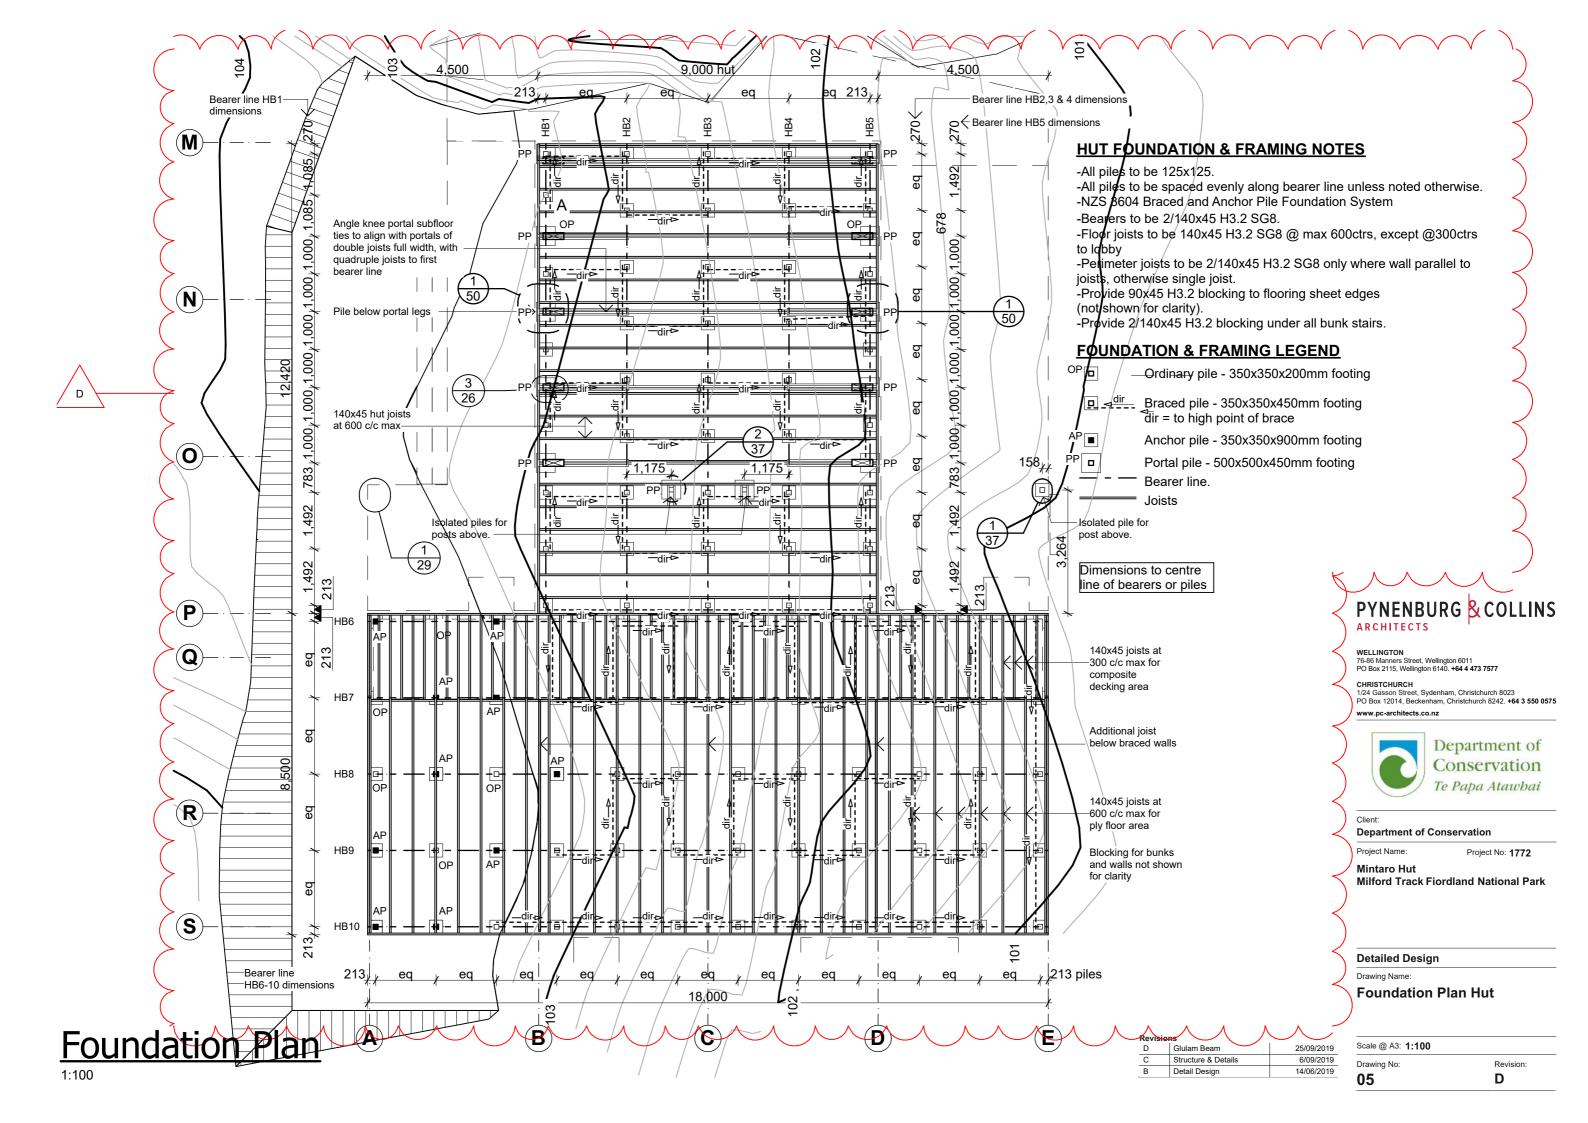

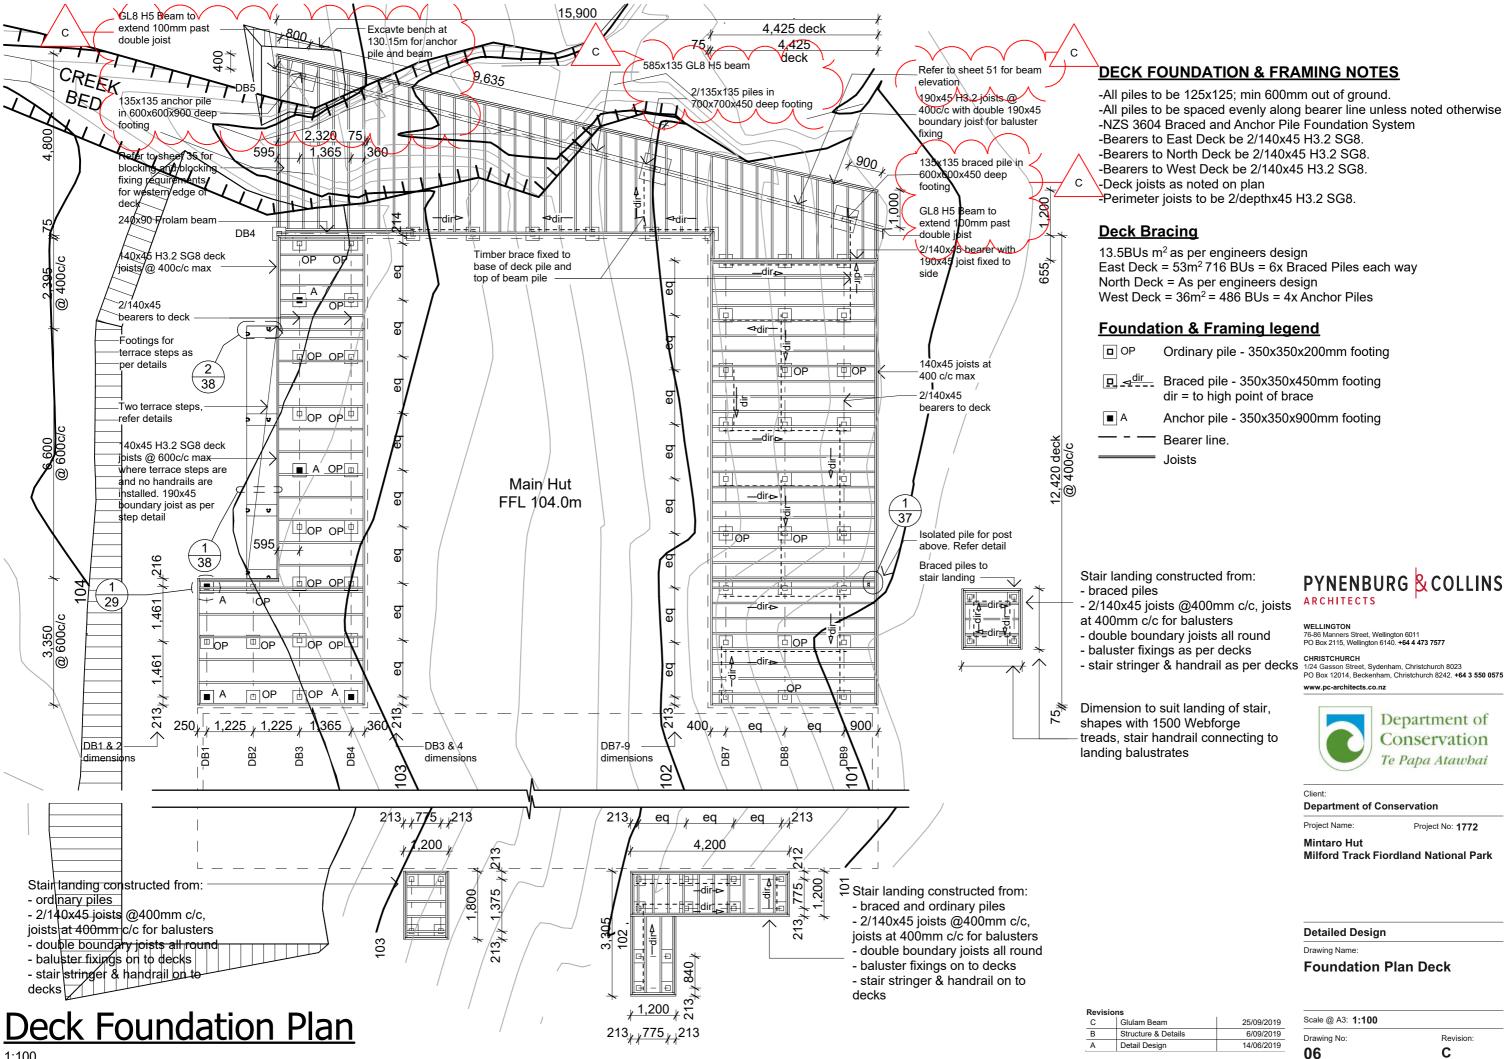

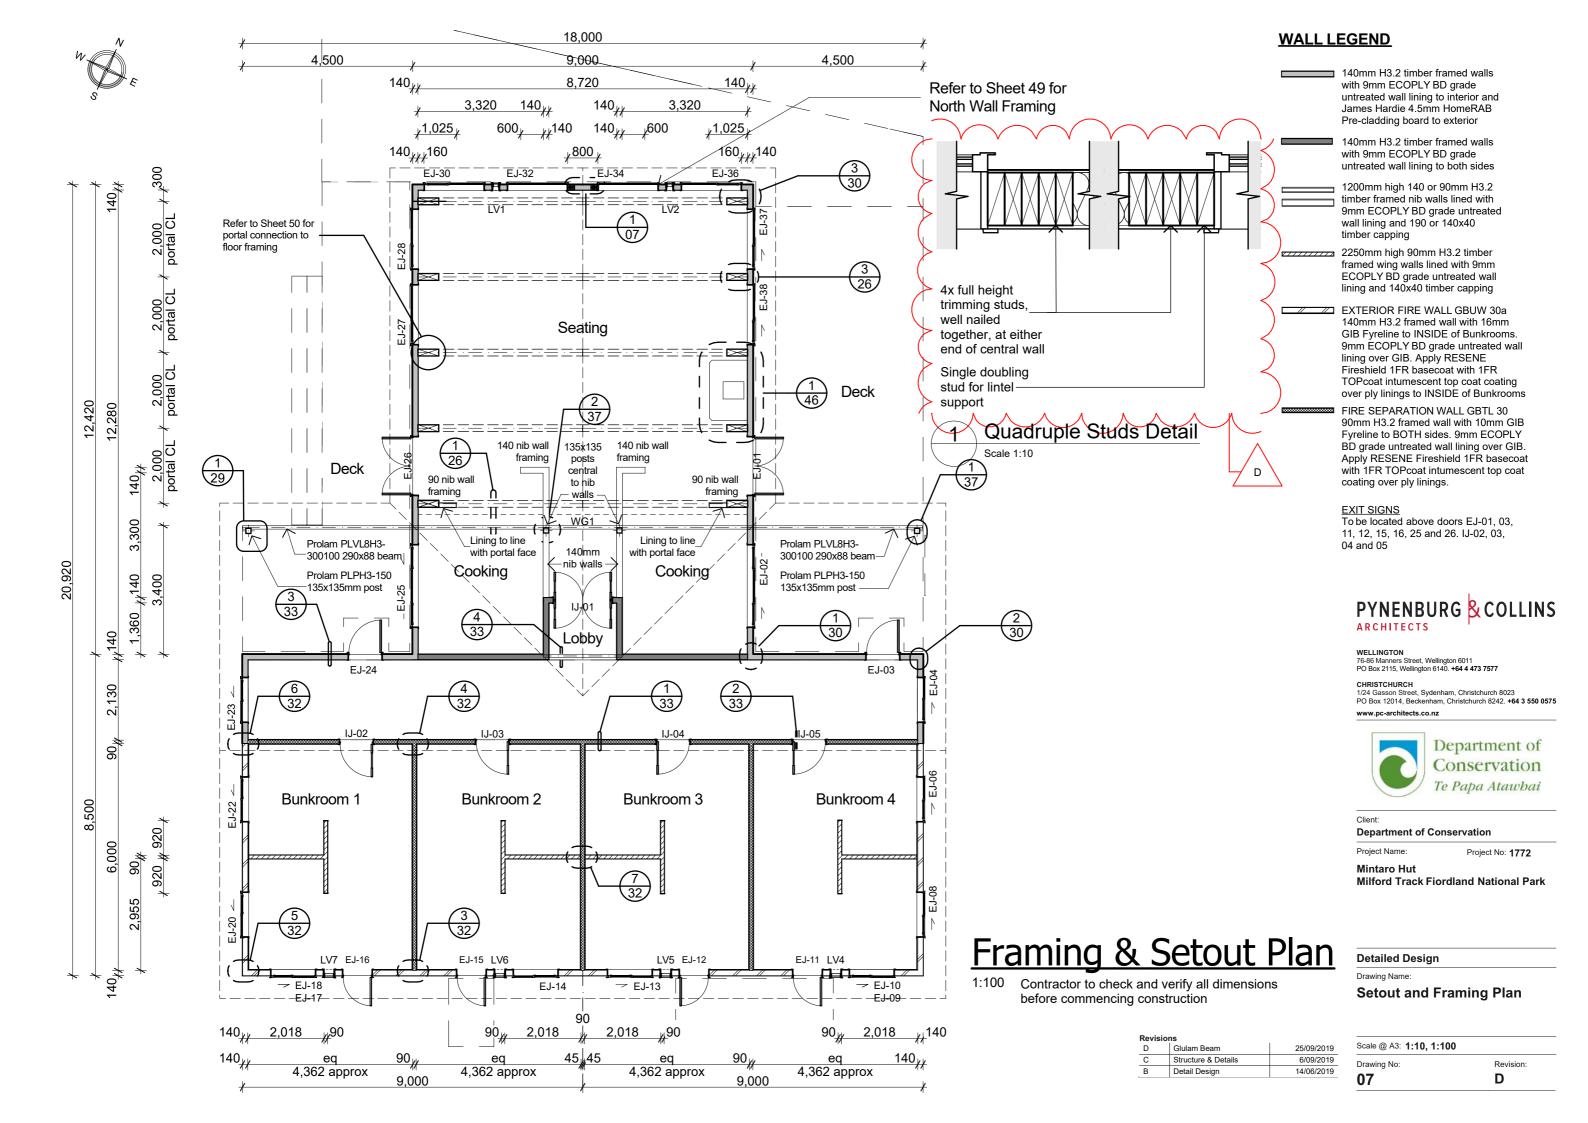

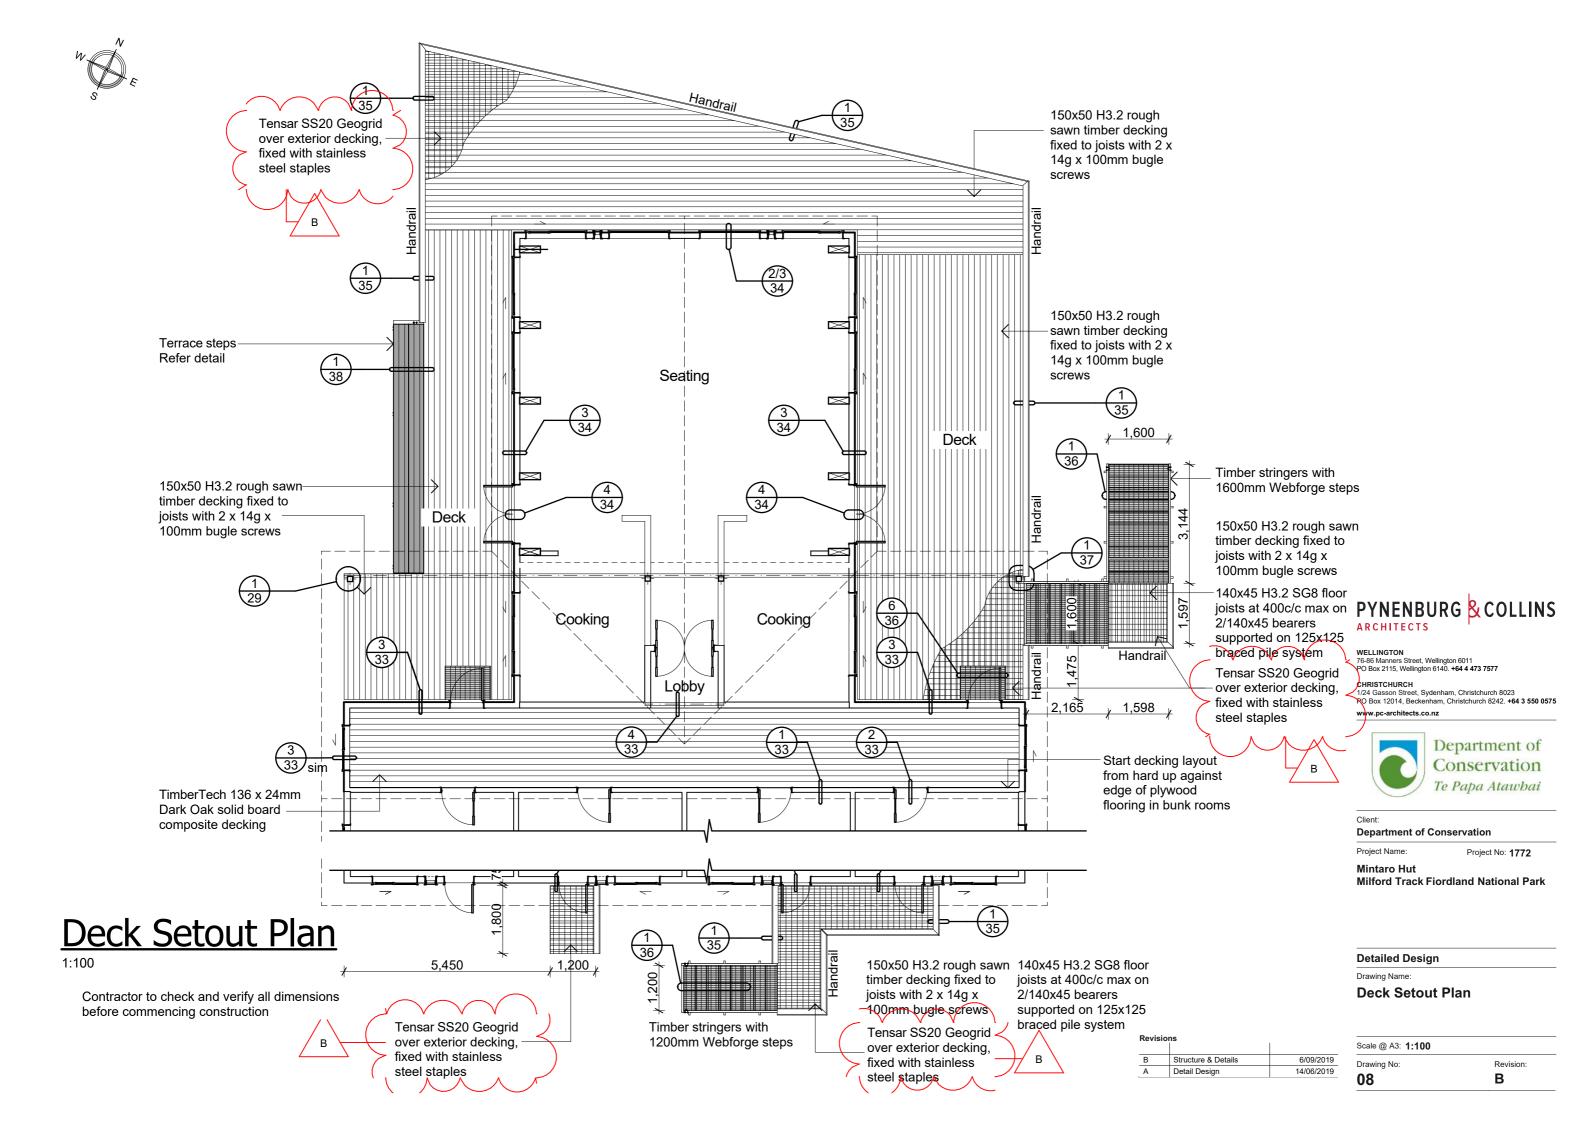


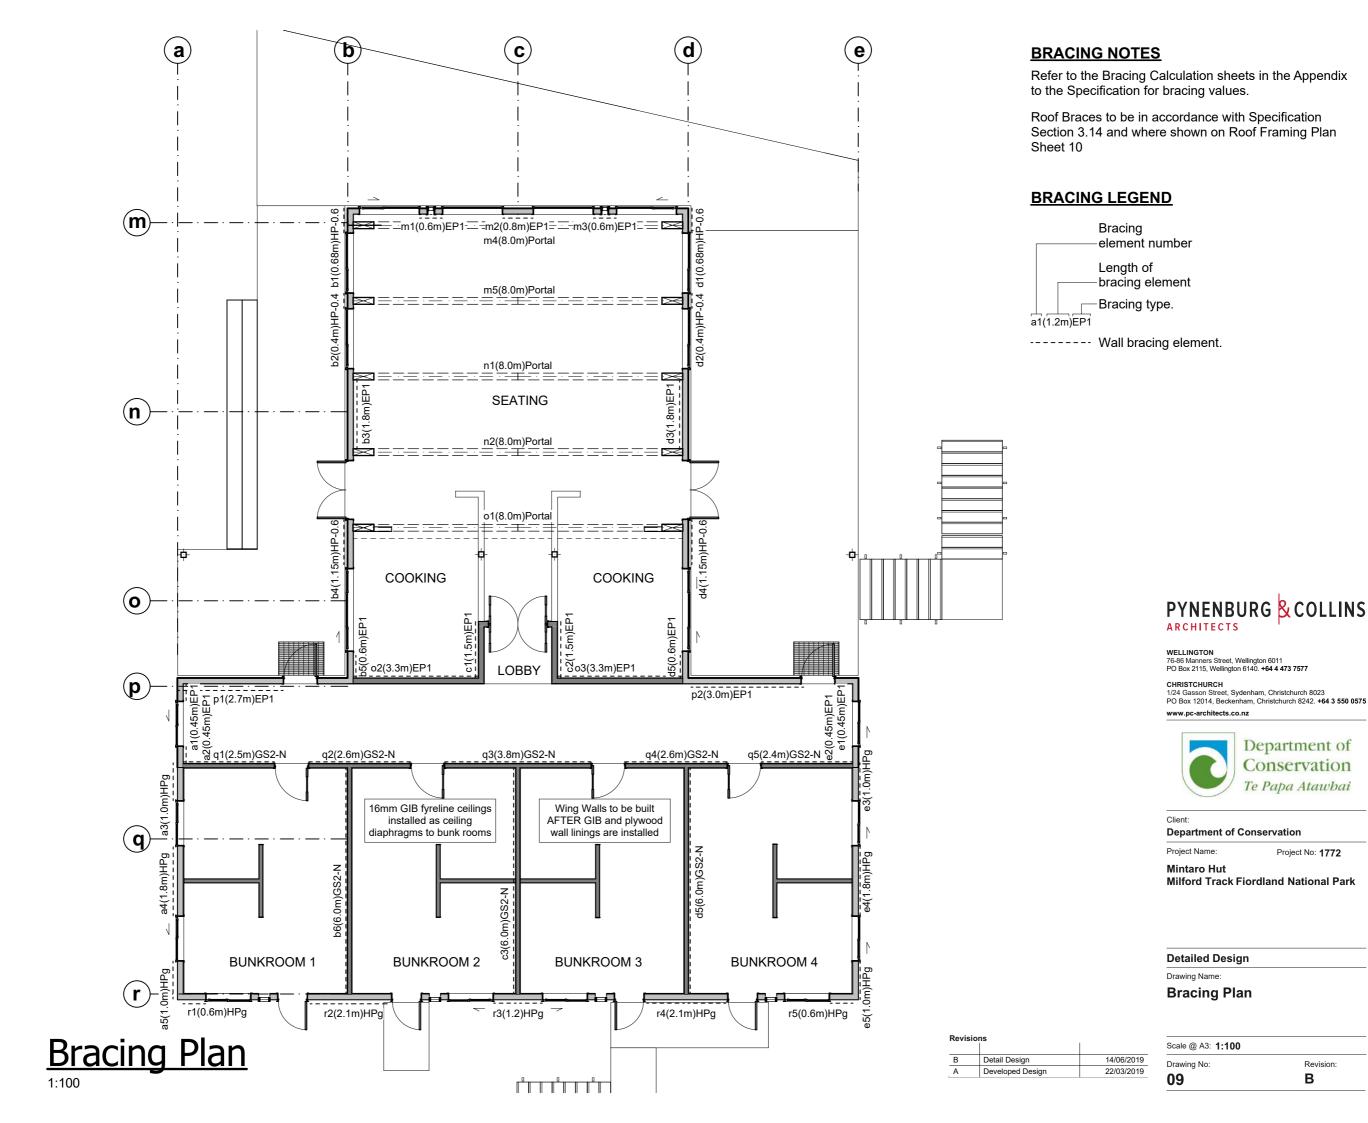



Project No: 1772

Revision:


В

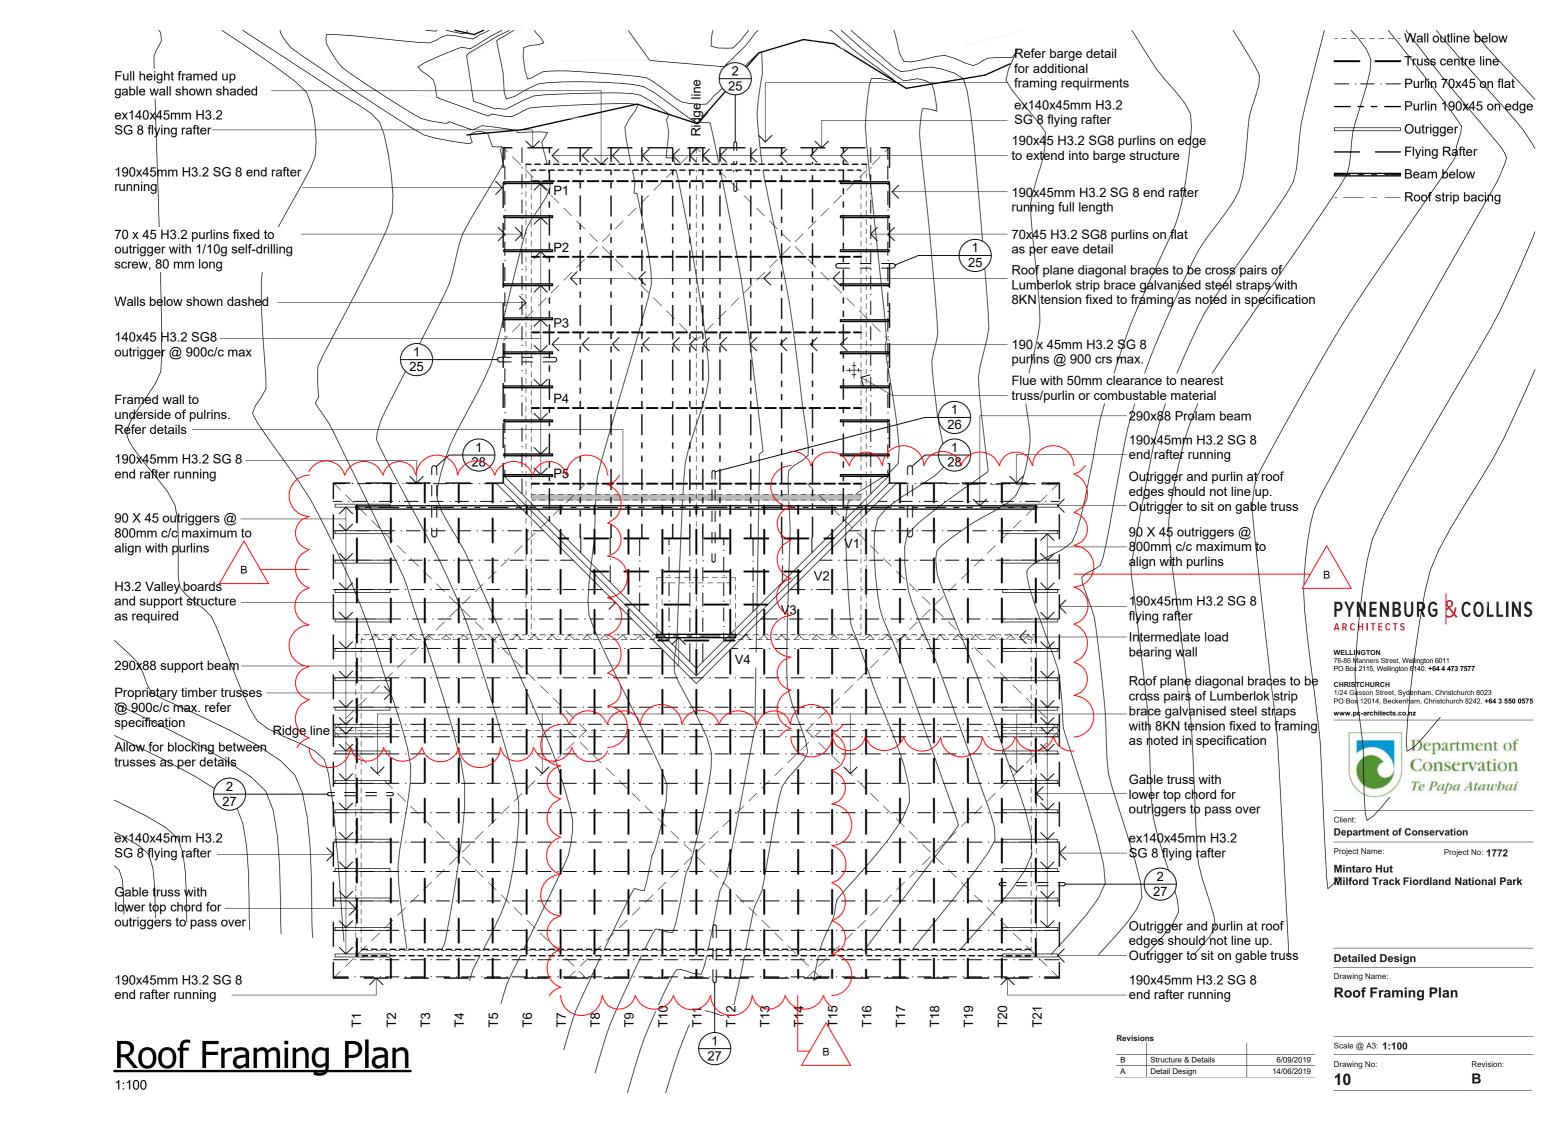

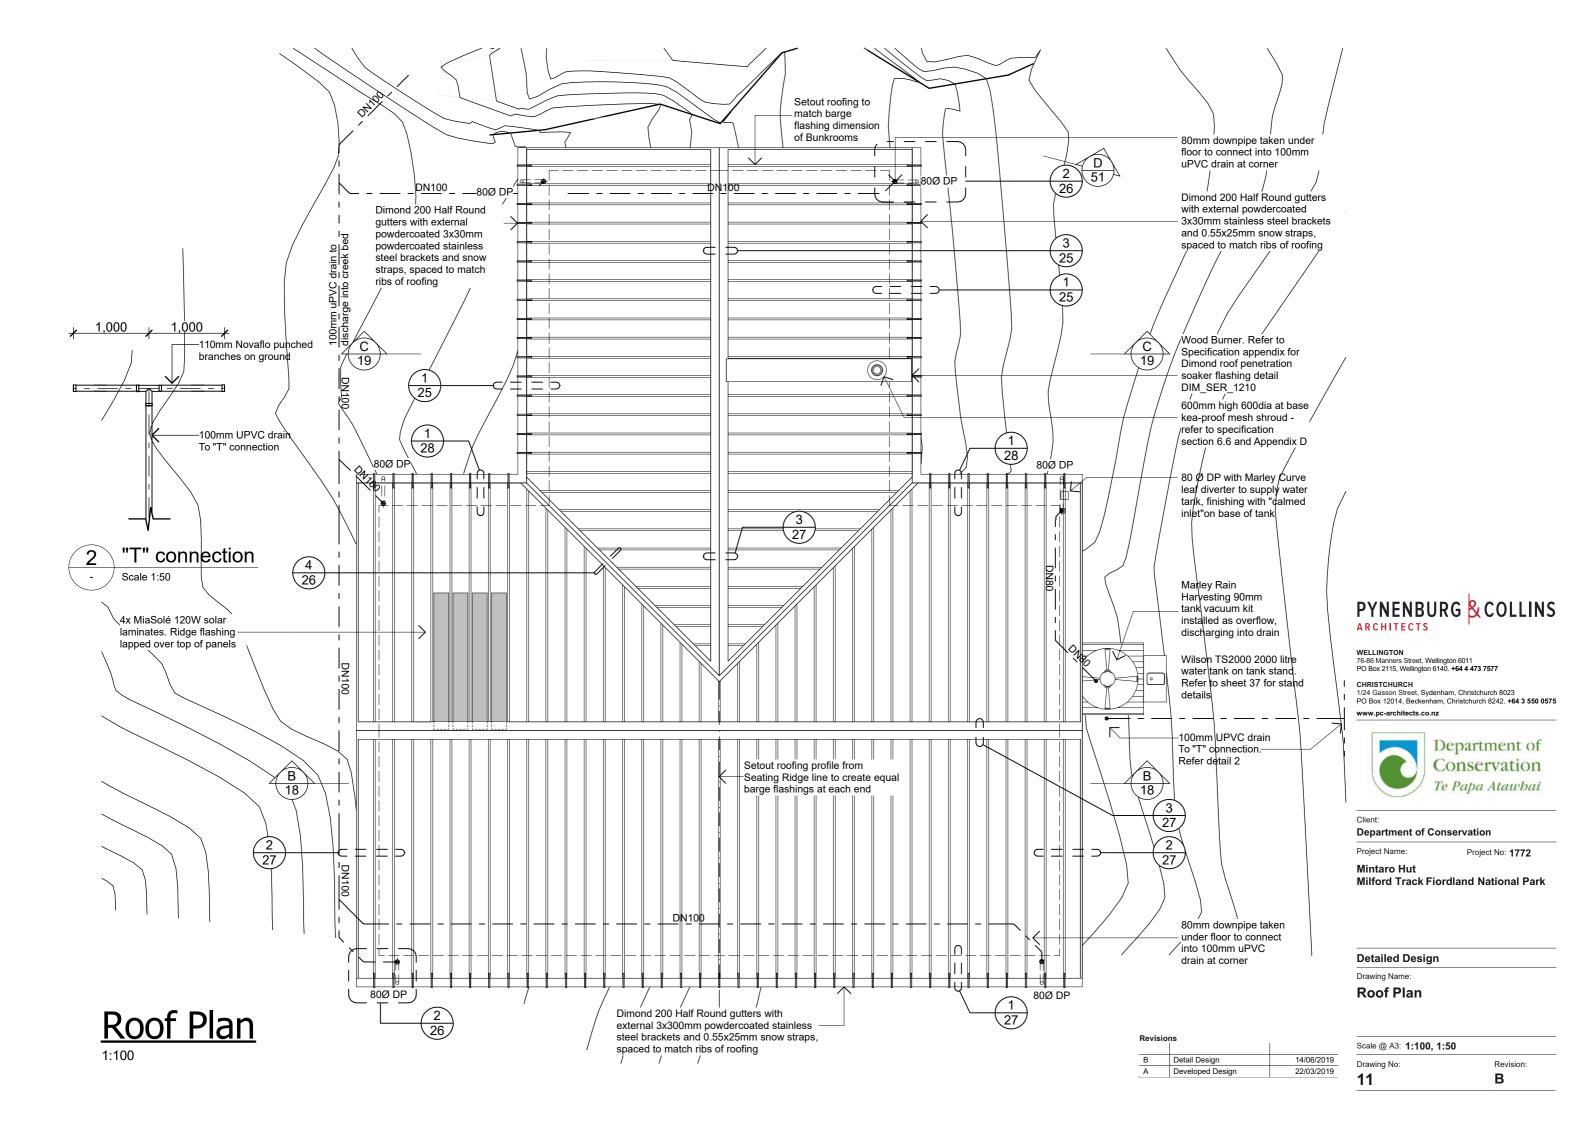

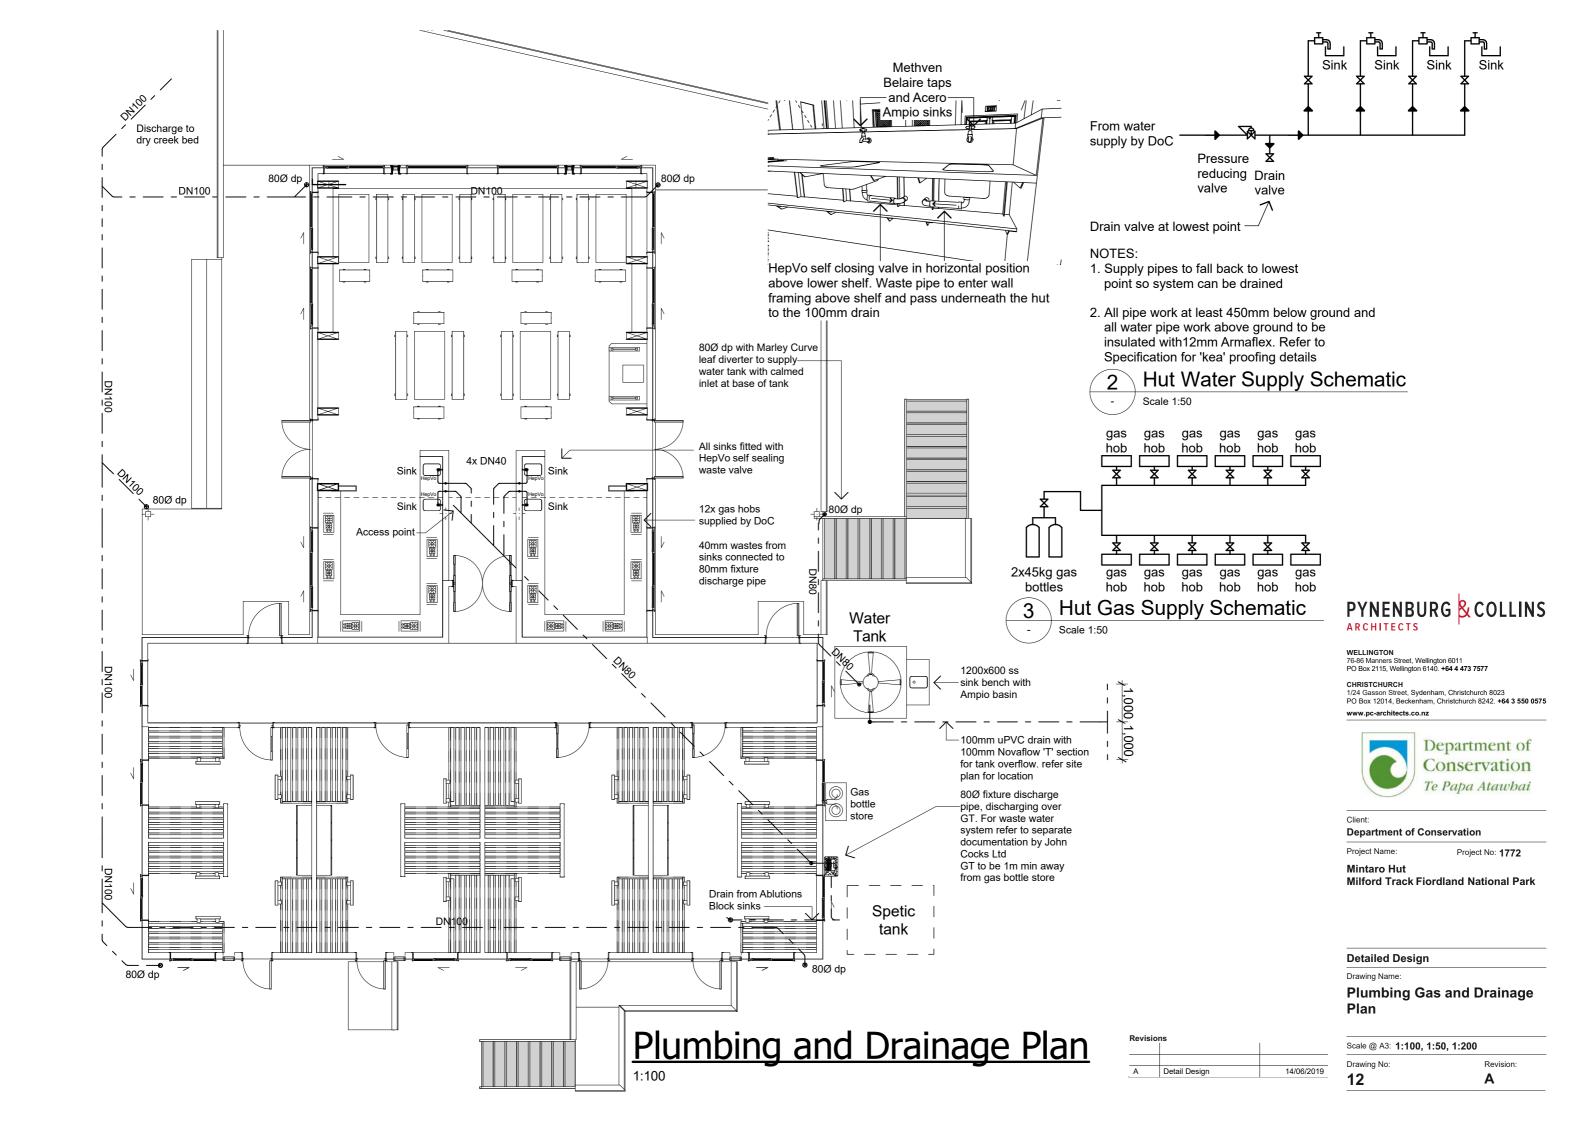



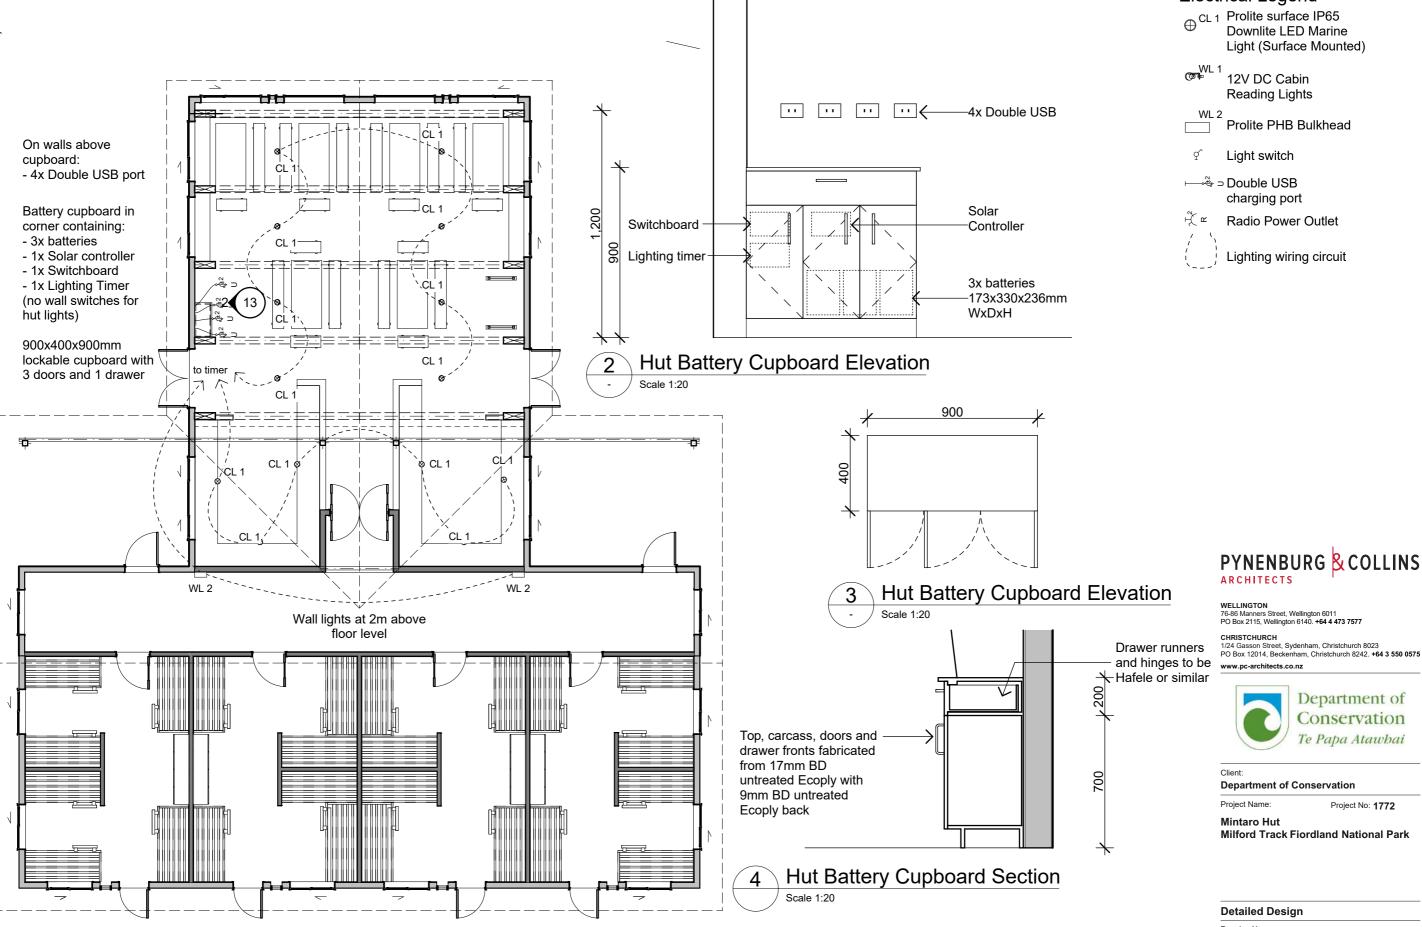

Electrical Plan


Revisions			
	В	Detail Design	14/06/2019
	Α	Developed Design	22/03/2019


Drawing Name:

Electrical Legend

Electrical Plan

Scale @ A3: 1:100, 1:20	
Drawing No:	Revision:
13	В

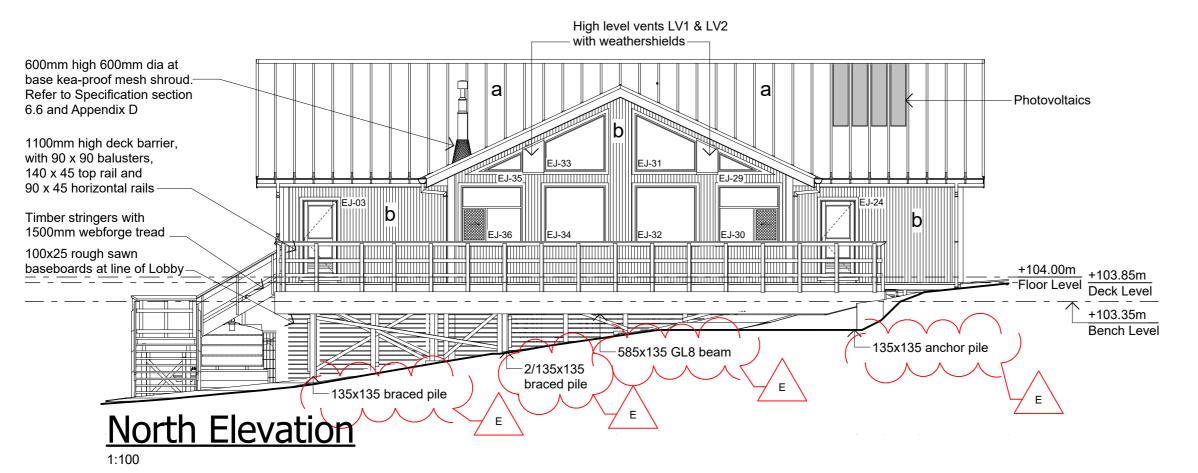

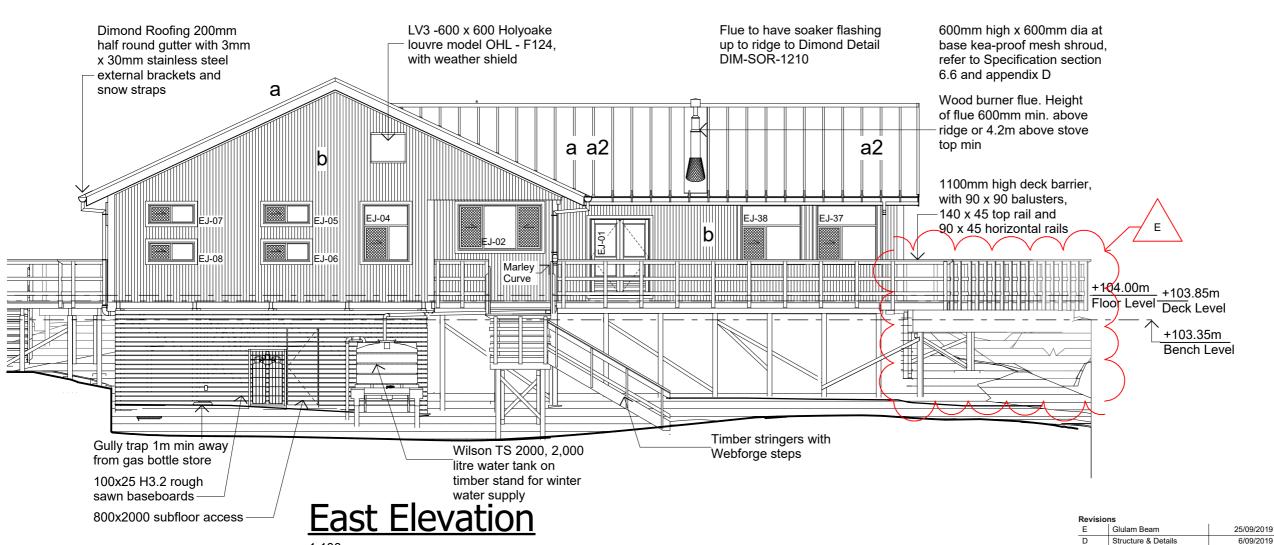

Material Notes:

- COLORCOTE Zinacore Dimond Solar Rib roofing over SISALATION SUREWRAP roofing underlay over 70 x 45 H3.2 purlins on flat @ 800c/c max. evenly spaced, with end purlins @ 500mm c/c. Refer specification for fixings of roofing and purlins.
- a2 COLORCOTE Zinacore Dimond Solar Rib roofing over SISALATION SUREWRAP roofing underlay over 190 x 45 H3.2 purlins on edge @ 900c/c max. evenly spaced, with end purlins @ 500mm c/c. Refer specification for fixings of roofing and
- COLORCOTE Zinacore 0.40 BMT CORRUGATE PROFILE cladding over cavity battens over Sisalation SureWrap wall underlay over 4.5mm HomeRAB Pre-Cladding board system over timber framing
- CHH 9mm ECOPLY BD grade untreated ceiling lining over 70 x 35 H1.2 battens @
- CHH 9mm ECOPLY BD grade untreated wall lining with 10mm gap to flooring
- CHH 19mm ECOPLY CD grade H3.2 CCA 2400x1200 LS flooring over timber joists. Refer to foundation plan for sub floor framing sizes & c/c.
- 150x50 rough sawn H3.2 Radiata with top edges arised with webforge insert at doors Tensar SS20 Geogrid over exterior decking,
- 4.5mm Hardiflex with PVC jointers
- CHH 9mm Ecoply BD grade untreated ply over 1 layer 10mm Gib Fyreline, with ply finished with Fireshield IFR clear intumescent coating
- h2 CHH 9mm Ecoply BD grade untreated ply over 1 layers 16mm Gib Fyreline, with ply finished with Fireshield IFR clear intumescent coating
- 1 layer 16mm Gib Fyreline

PYNENBURG & COLLINS **ARCHITECTS**

WELLINGTON 76-86 Manners Street, Wellington 6011 PO Box 2115, Wellington 6140. **+64 4 473 7577**

CHRISTCHURCH
1/24 Gasson Street, Sydenham, Christchurch 8023
PO Box 12014, Beckenham, Christchurch 8242. +64 3 550 0575 www.pc-architects.co.nz



Department of Conservation

Project Name:

Project No: 1772

Mintaro Hut

Milford Track Fiordland National Park


Detailed Design


Drawing Name:

Detail Design

Elevations

Scale @ A3: 1:100	
Drawing No:	Revision:
14	E

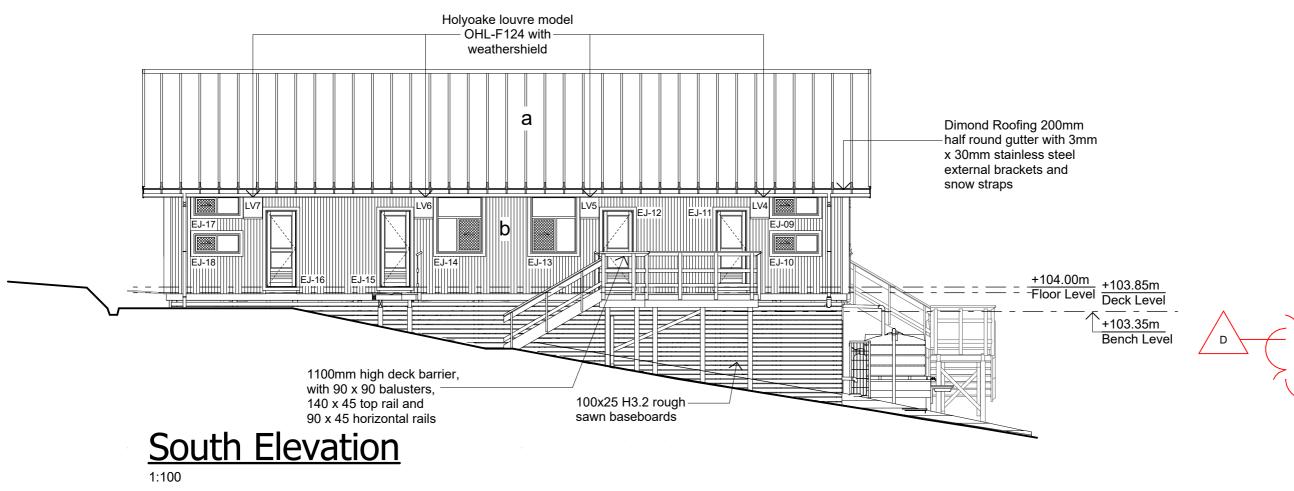

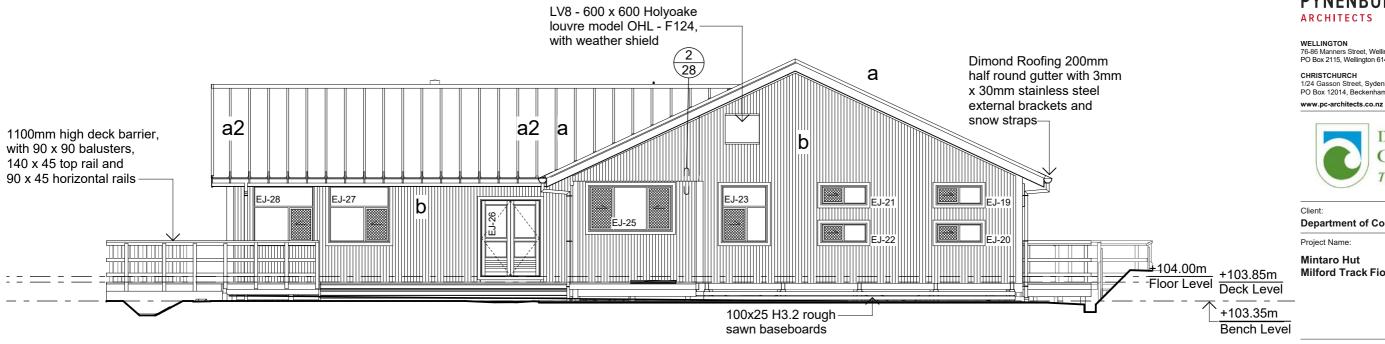

West Elevation

evisions			
D	Structure & Details	6/09/2019	
С	Detail Design	14/06/2019	
В	Developed Design	22/03/2019	

Material Notes:

COLORCOTE Zinacore Dimond Solar Rib roofing over SISALATION SUREWRAP roofing underlay over 70 x 45 H3.2 purlins on flat @ 800c/c max. evenly spaced, with end purlins @ 500mm c/c. Refer specification for fixings of roofing and purlins.

a2 COLORCOTE Zinacore Dimond Solar Rib roofing over SISALATION SUREWRAP roofing underlay over 190 x 45 H3.2 purlins on edge @ 900c/c max. evenly spaced, with end purlins @ 500mm c/c. Refer specification for fixings of roofing and

COLORCOTE Zinacore 0.40 BMT CORRUGATE PROFILE cladding over cavity battens over Sisalation SureWrap wall underlay over 4.5mm HomeRAB Pre-Cladding board system over timber framing

CHH 9mm ECOPLY BD grade untreated C ceiling lining over 70 x 35 H1.2 battens @

CHH 9mm ECOPLY BD grade untreated wall lining with 10mm gap to flooring.

CHH 19mm ECOPLY CD grade H3.2 CCA 2400x1200 LS flooring over timber joists.

Refer to foundation plan for sub floor-framing sizes & c/c.

150x50 rough sawn H3.2 Radiata with top edges arised with webforge insert at doors
Tensar SS20 Geogrid over exterior decking, fixed with stainless steel staples

4.5mm Hardiflex with PVC jointers CHH 9mm Ecoply BD grade untreated ply

over 1 layer 10mm Gib Fyreline, with ply finished with Fireshield IFR clear intumescent coating

h2 CHH 9mm Ecoply BD grade untreated ply over 1 layers 16mm Gib Fyreline, with ply finished with Fireshield IFR clear intumescent coating

1 layer 16mm Gib Fyreline

PYNENBURG & COLLINS **ARCHITECTS**

76-86 Manners Street, Wellington 6011 PO Box 2115, Wellington 6140. **+64 4 473 7577**

CHRISTCHURCH
1/24 Gasson Street, Sydenham, Christchurch 8023
PO Box 12014, Beckenham, Christchurch 8242. +64 3 550 0575



Department of Conservation

Project Name:

Project No: 1772

Mintaro Hut


Milford Track Fiordland National Park

Detailed Design

Drawing Name:

Elevations

Scale @ A3: 1:100 Drawing No: Revision: 15 D

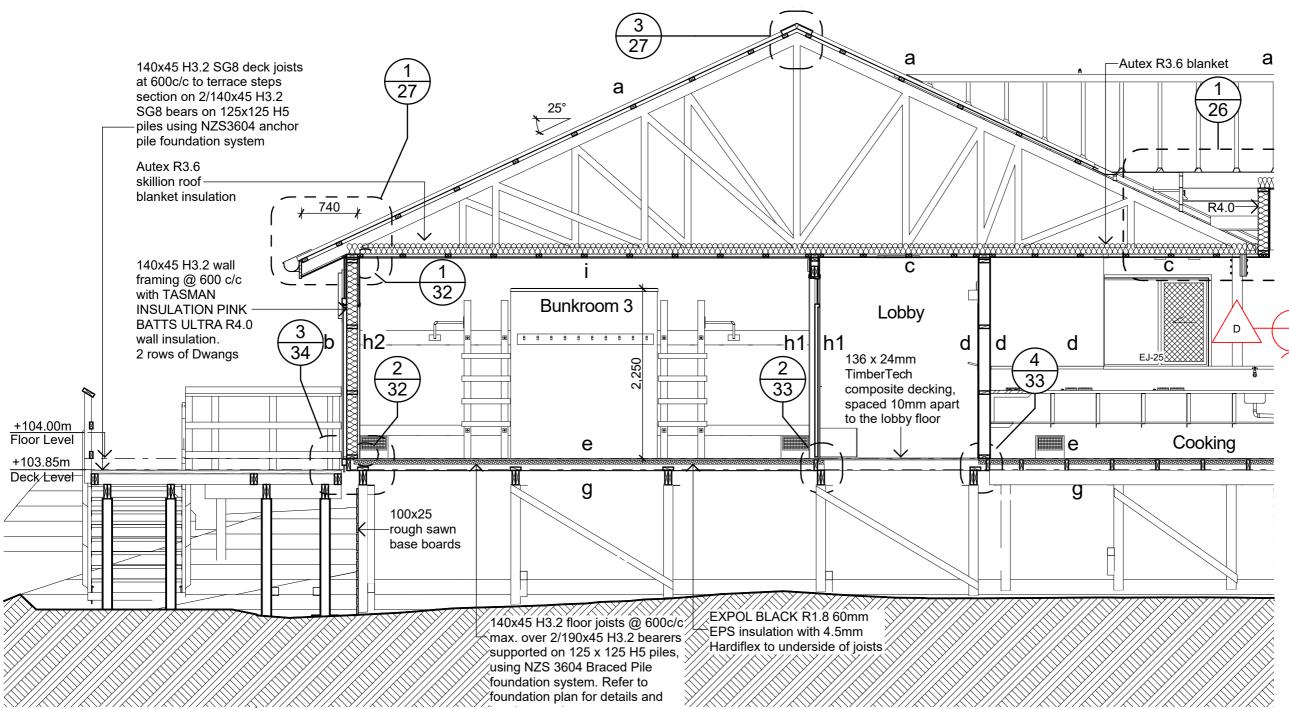

Section A

Material Notes:

COLORCOTE Zinacore Dimond Solar Rib roofing over SISALATION SUREWRAP roofing underlay over 70 x 45 H3.2 purlins on flat @ 800c/c max. evenly spaced, with end purlins @ 500mm c/c. Refer specification for fixings of roofing and purlins.

a2 COLORCOTE Zinacore Dimond Solar Rib roofing over SISALATION SUREWRAP roofing underlay over 190 x 45 H3.2 purlins on edge @ 900c/c max. evenly spaced, with end purlins @ 500mm c/c. Refer specification for fixings of roofing and

COLORCOTE Zinacore 0.40 BMT CORRUGATE PROFILE cladding over cavity battens over Sisalation SureWrap wall underlay over 4.5mm HomeRAB Pre-Cladding board system over timber framing

CHH 9mm ECOPLY BD grade untreated ceiling lining over 70 x 35 H1.2 battens @

CHH 9mm ECOPLY BD grade untreated wall lining with 10mm gap to flooring.

CHH 19mm ECOPLY CD grade H3.2 CCA 2400x1200 LS flooring over timber joists. Refer to foundation plan for sub floor framing sizes & e/c.

150x50 rough sawn H3.2 Radiata with top edges arised with webforge insert at doors
Tensar SS20 Geogrid over exterior decking, fixed with stainless steel staples

4.5mm Hardiflex with PVC jointers

CHH 9mm Ecoply BD grade untreated ply over 1 layer 10mm Gib Fyreline, with ply finished with Fireshield IFR clear intumescent coating

h2 CHH 9mm Ecoply BD grade untreated ply over 1 layers 16mm Gib Fyreline, with ply finished with Fireshield IFR clear intumescent coating

1 layer 16mm Gib Fyreline

PYNENBURG & COLLINS **ARCHITECTS**

WELLINGTON 76-86 Manners Street, Wellington 6011 PO Box 2115, Wellington 6140. +64 4 473 7577

CHRISTCHURCH
1/24 Gasson Street, Sydenham, Christchurch 8023
PO Box 12014, Beckenham, Christchurch 8242. +64 3 550 0575 www.pc-architects.co.nz



Department of Conservation

Project Name:

Project No: 1772

Revision: D

Mintaro Hut


Milford Track Fiordland National Park

Detailed Design

Drawing Name:

Section A

Structu	re & Details	6/09/2019	Scale @ A3: 1:50
Detail D	Design	14/06/2019	Drawing No:
Develo	ped Design	22/03/2019	· ·
			16

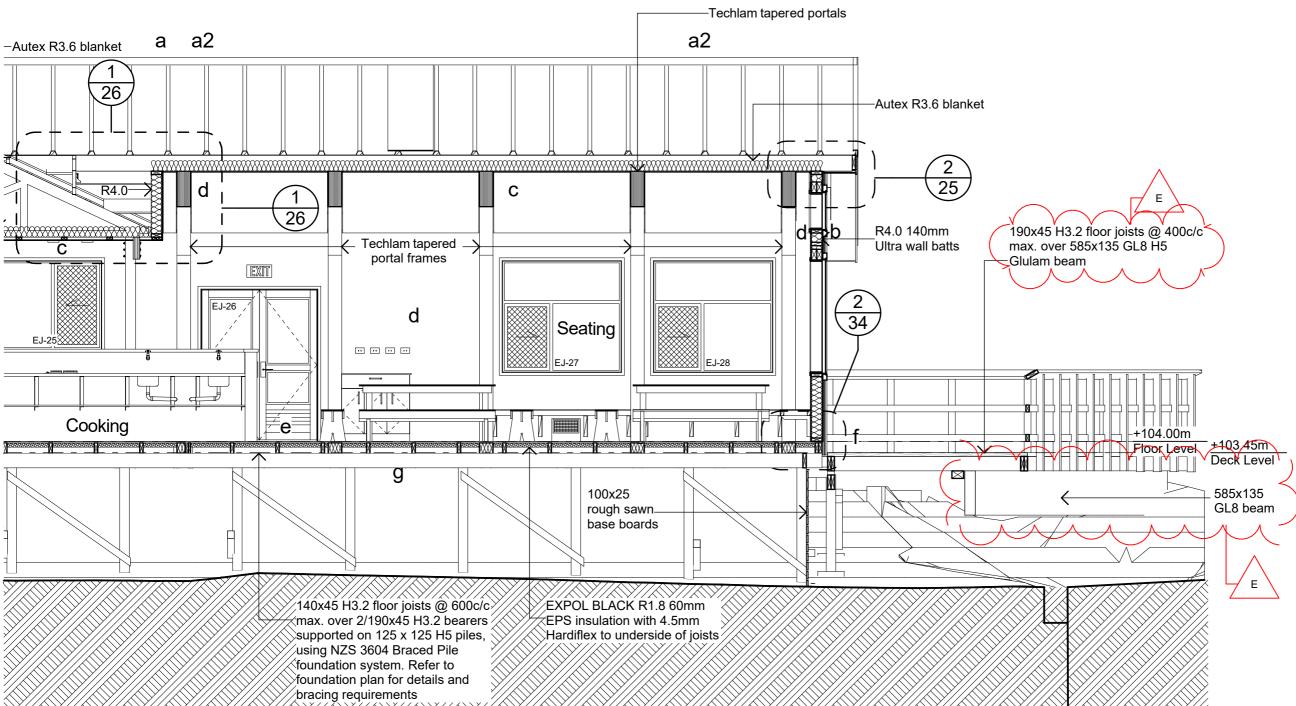

Section A

Glulam Bean 25/09/2019 Structure & Details 6/09/2019 Detail Design

Material Notes:

- COLORCOTE Zinacore Dimond Solar Rib roofing over SISALATION SUREWRAP roofing underlay over 70 x 45 H3.2 purlins on flat @ 800c/c max. evenly spaced, with end purlins @ 500mm c/c. Refer specification for fixings of roofing and purlins.
- a2 COLORCOTE Zinacore Dimond Solar Rib roofing over SISALATION SUREWRAP roofing underlay over 190 x 45 H3.2 purlins on edge @ 900c/c max. evenly spaced, with end purlins @ 500mm c/c. Refer specification for fixings of roofing and
- COLORCOTE Zinacore 0.40 BMT CORRUGATE PROFILE cladding over cavity battens over Sisalation SureWrap wall underlay over 4.5mm HomeRAB Pre-Cladding board system over timber framing
- CHH 9mm ECOPLY BD grade untreated C ceiling lining over 70 x 35 H1.2 battens @
- CHH 9mm ECOPLY BD grade untreated wall lining with 10mm gap to flooring.
- CHH 19mm ECOPLY CD grade H3.2 CCA 2400x1200 LS flooring over timber joists. Refer to foundation plan for sub floor framing sizes & c/c.
- 150x50 rough sawn H3.2 Radiata with top edges arised with webforge insert at doors Tensar SS20 Geogrid over exterior decking, fixed with stainless steel staples
- 4.5mm Hardiflex with PVC jointers
- CHH 9mm Ecoply BD grade untreated ply over 1 layer 10mm Gib Fyreline, with ply finished with Fireshield IFR clear intumescent coating
- h2 CHH 9mm Ecoply BD grade untreated ply over 1 layers 16mm Gib Fyreline, with ply finished with Fireshield IFR clear intumescent coating

1 layer 16mm Gib Fyreline

PYNENBURG & COLLINS **ARCHITECTS**

WELLINGTON

76-86 Manners Street, Wellington 6011 PO Box 2115, Wellington 6140. **+64 4 473 7577**

CHRISTCHURCH
1/24 Gasson Street, Sydenham, Christchurch 8023
PO Box 12014, Beckenham, Christchurch 8242. +64 3 550 0575 www.pc-architects.co.nz



Department of Conservation

Project Name:

Project No: 1772

Mintaro Hut


Milford Track Fiordland National Park

Detailed Design

Drawing Name:

Section A

Scale @ A3: 1:50 Drawing No: Revision: 17 Ε

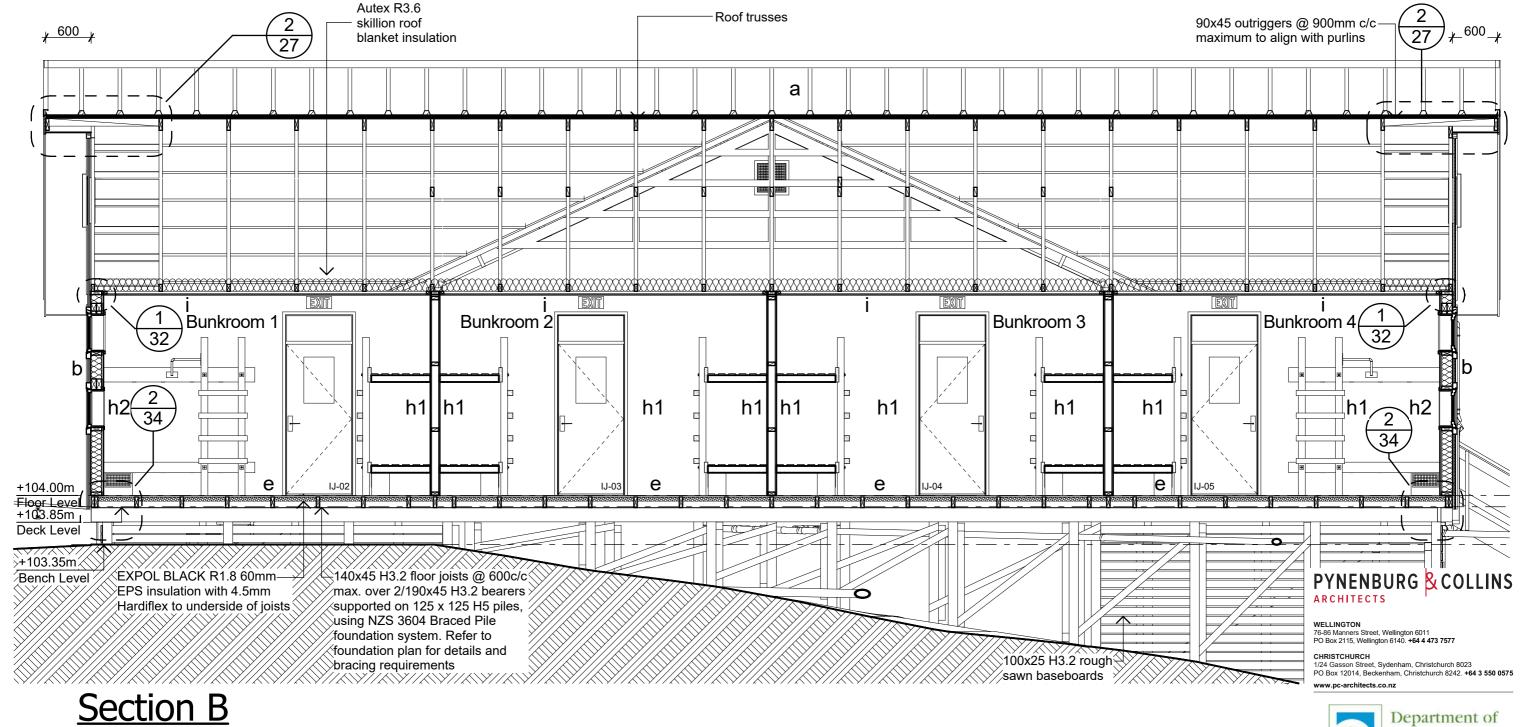

1:50

Material Notes:

- COLORCOTE Zinacore Dimond Solar Rib roofing over SISALATION SUREWRAP roofing underlay over 70 x 45 H3.2 purlins on flat @ 800c/c max. evenly spaced, with end purlins @ 500mm c/c. Refer specification for fixings of roofing and purlins.
- COLORCOTE Zinacore Dimond Solar Rib roofing over SISALATION SUREWRAP roofing underlay over 190 x 45 H3.2 purlins on edge @ 900c/c max. evenly spaced, with end purlins @ 500mm c/c. Refer specification for fixings of roofing and purlins.
- D COLORCOTE Zinacore 0.40 BMT CORRUGATE PROFILE cladding over cavity battens over Sisalation SureWrap wall underlay over 4.5mm HomeRAB Pre-Cladding board system over timber framing
- C CHH 9mm ECOPLY BD grade untreated ceiling lining over 70 x 35 H1.2 battens @ 600c/c max.

- d CHH 9mm ECOPLY BD grade untreated wall lining with 10mm gap to flooring.
- CHH 19mm ECOPLY CD grade H3.2 CCA 2400x1200 LS flooring over timber joists. Refer to foundation plan for sub floor framing sizes & v.c.

150x50 rough sawn H3.2 Radiata with top edges arised with webforge insert at doors Tensar SS20 Geogrid over exterior decking, fixed with stainless steel staples

- 4.5mm Hardiflex with PVC jointers
- CHH 9mm Ecoply BD grade untreated ply over 1 layer 10mm Gib Fyreline, with ply finished with Fireshield IFR clear intumescent coating
- h2 CHH 9mm Ecoply BD grade untreated ply over 1 layers 16mm Gib Fyreline, with ply finished with Fireshield IFR clear intumescent coating
- 1 layer 16mm Gib Fyreline



ilent:

Department of Conservation

Project Name: Project No: 1772

Mintaro Hut

Milford Track Fiordland National Park


Detailed Design

Drawing Name:

Section B

| Structure & Details | 6/09/2019 | Scale @ A3: 1:50 |
| Detail Design | 14/06/2019 | Drawing No: |

Scale @ A3: 1:50	
Drawing No:	Revision:
18	D

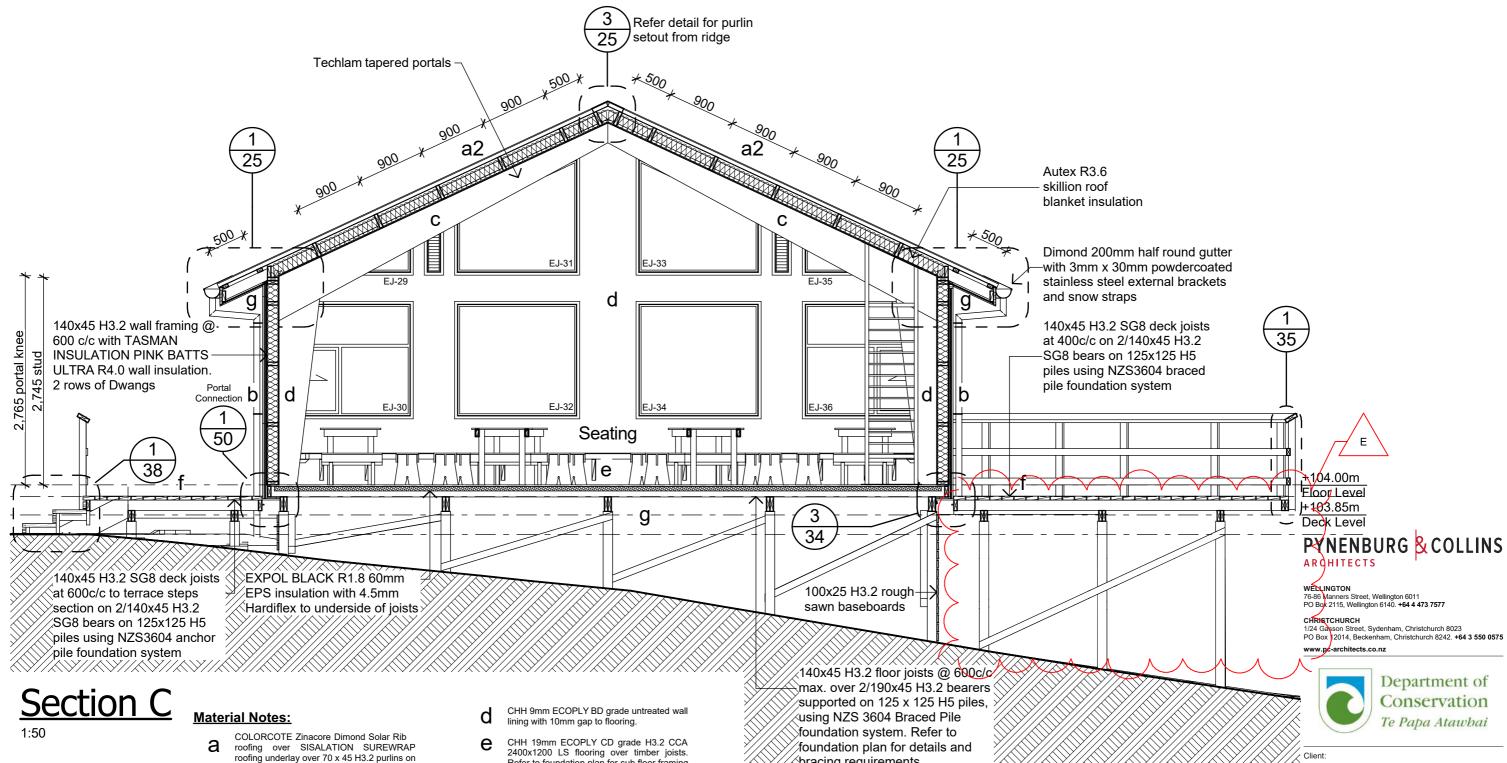

- flat @ 800c/c max. evenly spaced, with end purlins @ 500mm c/c. Refer specification for fixings of roofing and purlins.
- a2 COLORCOTE Zinacore Dimond Solar Rib roofing over SISALATION SUREWRAP roofing underlay over 190 x 45 H3.2 purlins on edge @ 900c/c max. evenly spaced, with end purlins @ 500mm c/c. Refer specification for fixings of roofing and
- COLORCOTE Zinacore 0.40 BMT CORRUGATE PROFILE cladding over cavity battens over Sisalation SureWrap wall underlay over 4.5mm HomeRAB Pre-Cladding board system over timber framing
- CHH 9mm ECOPLY BD grade untreated ceiling lining over 70 x 35 H1.2 battens @ 600c/c max

- Refer to foundation plan for sub floor framing
- 150x50 rough sawn H3.2 Radiata with top edges arised with webforge insert at doors Tensar SS20 Geogrid over exterior decking, fixed with stainless steel staples
- 4.5mm Hardiflex with PVC jointers
- CHH 9mm Ecoply BD grade untreated ply over 1 layer 10mm Gib Fyreline, with ply finished with Fireshield IFR clear intumescent coating
- $h2^{\,\text{CHH 9mm Ecoply BD grade untreated ply}}_{\,\text{over 1 layers 16mm Gib Fyreline, with ply}}$ finished with Fireshield IFR clear intumescent coating
- 1 layer 16mm Gib Fyreline

bracing requirements

Department of Conservation

Project Name: Project No: 1772

Mintaro Hut

Milford Track Fiordland National Park


Detailed Design


Drawing Name:

Section C

Revisio	ns			
E	Glulam Beam	25/09/2019	Scale @	
D	Structure & Details	6/09/2019	Drawing I	
С	Detail Design	14/06/2019	40	

Scale @ A3: 1:50	
Drawing No:	Revision:
19	E

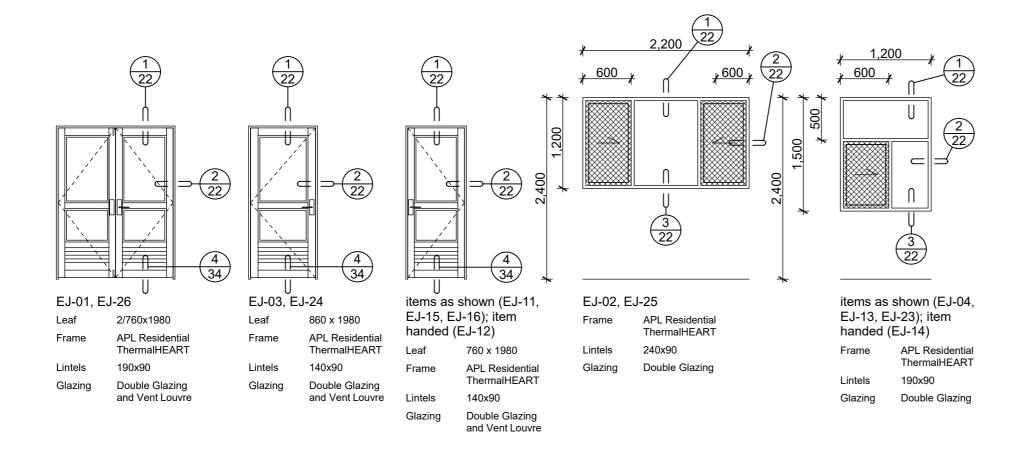

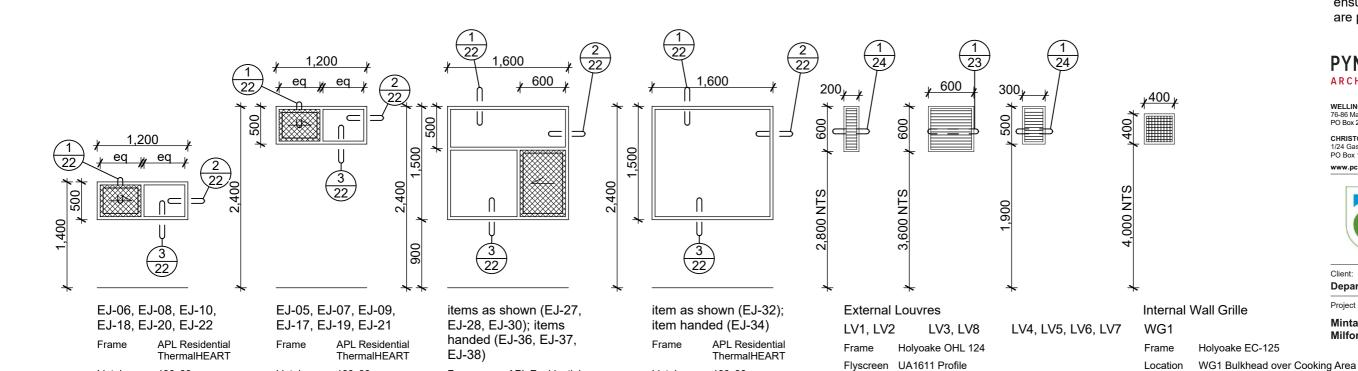

Lintels

Glazing

190x90

Double Glazing

190x90

Double Glazing

with bondlite to

interior pane

Lintels

Glazing

190x90

Double Glazing

with bondlite to

interior pane

Lintels

Glazing

Frame

Lintels

Glazing

APL Residential

ThermalHEART

Double Glazing

190x90

NOTES: Refer to Setout and Framing Plan for framing and lining requirements to ensure correct reveals are provided

PYNENBURG & COLLINS ARCHITECTS

WELLINGTON 76-86 Manners Street, Wellington 6011 PO Box 2115, Wellington 6140. +64 4 473 7577

CHRISTCHURCH
1/24 Gasson Street, Sydenham, Christchurch 8023
PO Box 12014, Beckenham, Christchurch 8242. +64 3 550 0575 www.pc-architects.co.nz



Department of Conservation

Project Name:

Project No: 1772

Mintaro Hut

Milford Track Fiordland National Park

Detailed Design

Drawing Name:

Window and Door Schedule

Revis	ions
	- 1


LV1, LV2 Seating Gables

LV3, LV8 Bunkroom Gables

LV4-7 South Wall Bunkrooms

В	Detail Design	14/06/2019
Α	Developed Design	22/03/2019

Scale @ A3: 1:50	
Drawing No:	Revision:
20	В

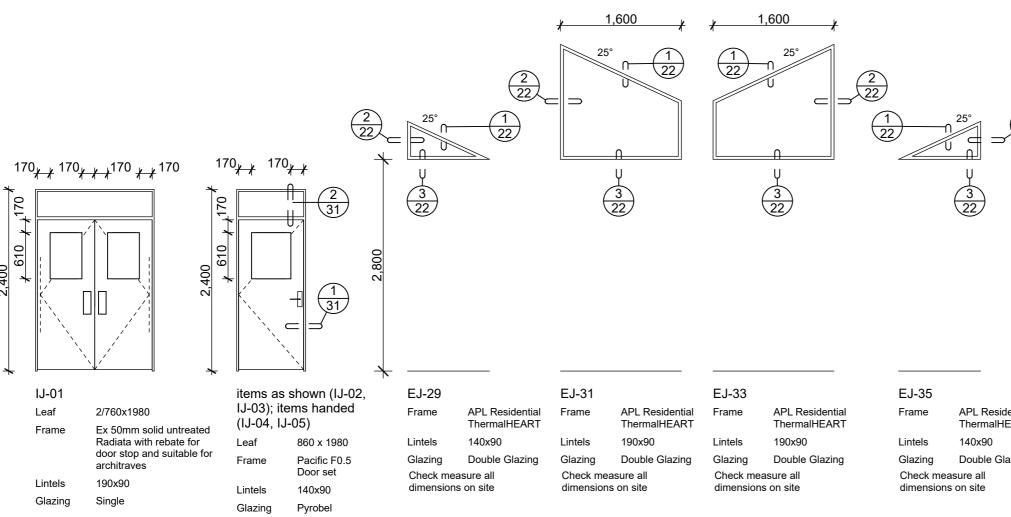

External Door Notes:

- EJ-01, EJ-03, EJ-11, EJ-12, EJ-15, EJ-16, EJ-24 & EJ-26 to be APL powder coated RESIDENTIAL THERMAL HEART HINGED door in powder coated aluminium frame, with H3.2 reveals and no sill. Refer to detail 4/34 for sill requirements
- Allow for 100mm top rail and stiles and double 100mm bottom rail 2.
- 3. EJ-01, EJ-03, EJ-11, EJ-12, EJ-15, EJ-16, EJ-24 & EJ-26 to have double-glazed unit to top panel and aluminium-faced 20mm EPS core insulated unit to bottom panel. Bottom panel to have 300mm high Holyoake OHL-F34 louvre fitted, complete with insect mesh to inside. Powder-coated weather shield to exterior of door over louvre
- EJ-01, EJ-03, EJ-16, EJ-24 and EJ-026 on Parliament hinges.
- All exterior doors to have 6584 SC Synergy short latch with L4801/70SC and L4905/70SC Lockwood square end plate furniture with lever handles, except EJ-01 and EJ-26 shall only have this hardware to active leaf
- EJ-01 and EJ-26 shall have towerbolts and 300x100 ss push plate/D handle to passive leaf
- EJ-11, EJ-12, EJ-15 and EJ-16 to have PC681 Wilson and Macindoe heavy duty latch back fitted
- Insect mesh to be Ullrich 18 x 16 x 0.009" grey fibreglass mesh


Internal Door Notes:

IJ-01 to have heavy duty double action spring hinges with 300x100 ss push plates both sides

IJ-02-05 to have 3574SC Synergy passage latch with LWA1905/70SC and LWA1805/70SC square end plate furniture with lever handles. Lockwood 724 door closer

Window Notes:

- EJ-29, EJ-31-35 to be APL powder coated aluminium RESIDENTIAL THERMAL HEART, double glazed unit
- 2. EJ-02, EJ-04, EJ-05-10, EJ-13, EJ-14, EJ-17-23, EJ-25, EJ-27, EJ-28, EJ-30, EJ-36-38 to be APL powder coated aluminium RESIDENTIAL ThermalHEART sliding window, double glazed units, with removable flyscreen mesh to sliding panel opening
- All reveals are to be H3.2 treated, ready to receive architraves
- Screw-fixed removable fine mesh flyscreens fabricated from Ullrich UA1611 flyscreen profile and Ullrich 18 x 16 x 0.009"grey fibreglass mesh

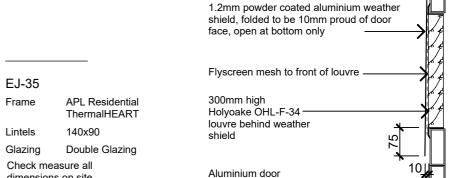

double bottom rail

Scale 1:10

2

1.2mm powder coated aluminium weather shield, folded to be 10mm proud of door face, open at


bottom only

300mm high Holyoake

Aluminium door rail

Scale 1:10

OHL-F-34 louvre behind weather shield

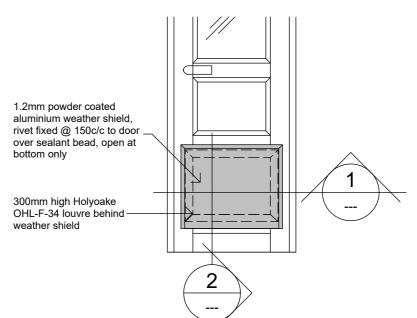



-Flyscreen over louvre

Aluminium door

WELLINGTON 76-86 Manners Street, Wellington 6011 PO Box 2115, Wellington 6140. **+64 4 473 7577**

CHRISTCHURCH
1/24 Gasson Street, Sydenham, Christchurch 8023
PO Box 12014, Beckenham, Christchurch 8242. +64 3 550 0575 www.pc-architects.co.nz



Department of Conservation

Project Name: Project No: 1772

Mintaro Hut


Detailed Design

Milford Track Fiordland National Park

Weather shield - Elevation Window and Door Schedule

Revis	lons		Scale @ A3: 1:50, 1:2
			Drawing No:
Α	Detail Design	14/06/2019	24
	•		21

:20, 1:10 Revision Α

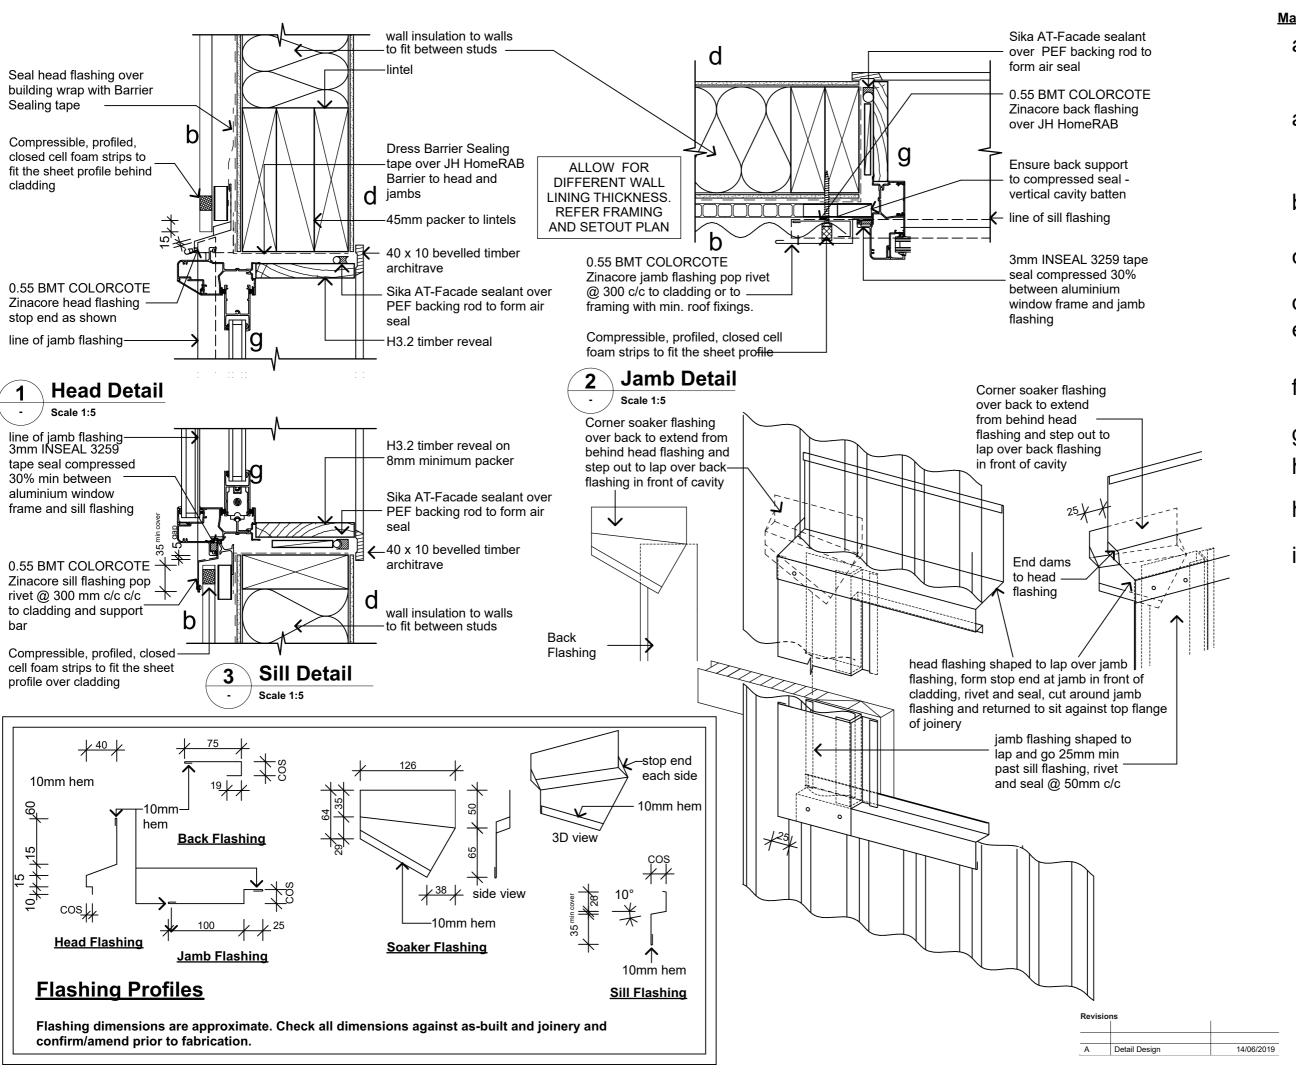

Material Notes:

- COLORCOTE Zinacore Dimond Solar Rib roofing over SISALATION SUREWRAP roofing underlay over 70 x 45 H3.2 purlins on flat @ 800c/c max. evenly spaced, with end purlins @ 500mm c/c. Refer specification for fixings of roofing and purlins.
- a2 COLORCOTE Zinacore Dimond Solar Rib roofing over SISALATION SUREWRAP roofing underlay over 190 x 45 H3.2 purlins on edge @ 900c/c max. evenly spaced, with end purlins @ 500mm c/c. Refer specification for fixings of roofing and
- COLORCOTE Zinacore 0.40 BMT CORRUGATE PROFILE cladding over cavity battens over Sisalation SureWrap wall underlay over 4.5mm HomeRAB Pre-Cladding board system over timber framing
- CHH 9mm ECOPLY BD grade untreated ceiling lining over 70 x 35 H1.2 battens @
- CHH 9mm ECOPLY BD grade untreated wall lining with 10mm gap to flooring.
- CHH 19mm ECOPLY CD grade H3.2 CCA 2400x1200 LS flooring over timber joists. Refer to foundation plan for sub floor framing
- 150x50 rough sawn H3.2 Radiata with top edges arised with webforge insert at doors Tensar SS20 Geogrid over exterior decking,
- 4.5mm Hardiflex with PVC jointers
- CHH 9mm Ecoply BD grade untreated ply over 1 layer 10mm Gib Fyreline, with ply finished with Fireshield IFR clear intumescent coating
- h2 CHH 9mm Ecoply BD grade untreated ply over 1 layers 16mm Gib Fyreline, with ply finished with Fireshield IFR clear intumescent coating
- 1 layer 16mm Gib Fyreline

PYNENBURG & COLLINS ARCHITECTS

WELLINGTON 76-86 Manners Street, Wellington 6011 PO Box 2115, Wellington 6140. **+64 4 473 7577**

CHRISTCHURCH
1/24 Gasson Street, Sydenham, Christchurch 8023
PO Box 12014, Beckenham, Christchurch 8242. +64 3 550 0575 www.pc-architects.co.nz



Department of Conservation

Project Name:

Project No: 1772

Mintaro Hut


Milford Track Fiordland National Park

Detailed Design

Drawing Name:


Window Details


Scale @ A3: 1:5	
Drawing No:	Revision:

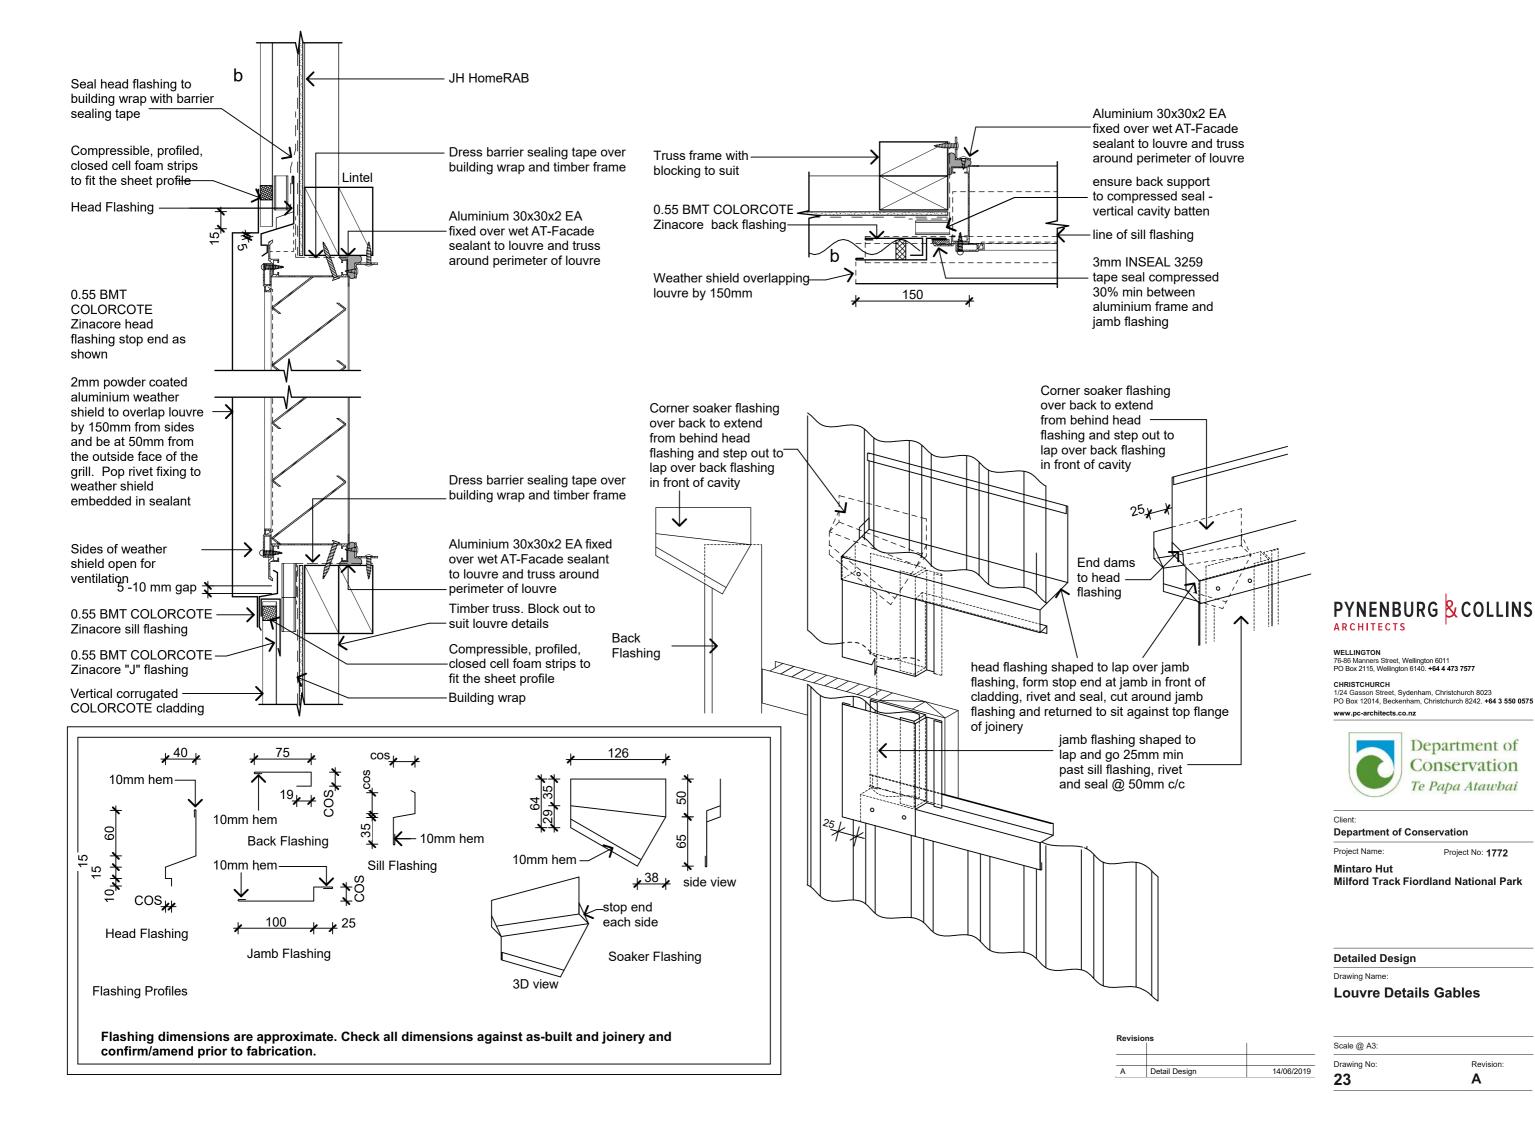


Project No: 1772

Α

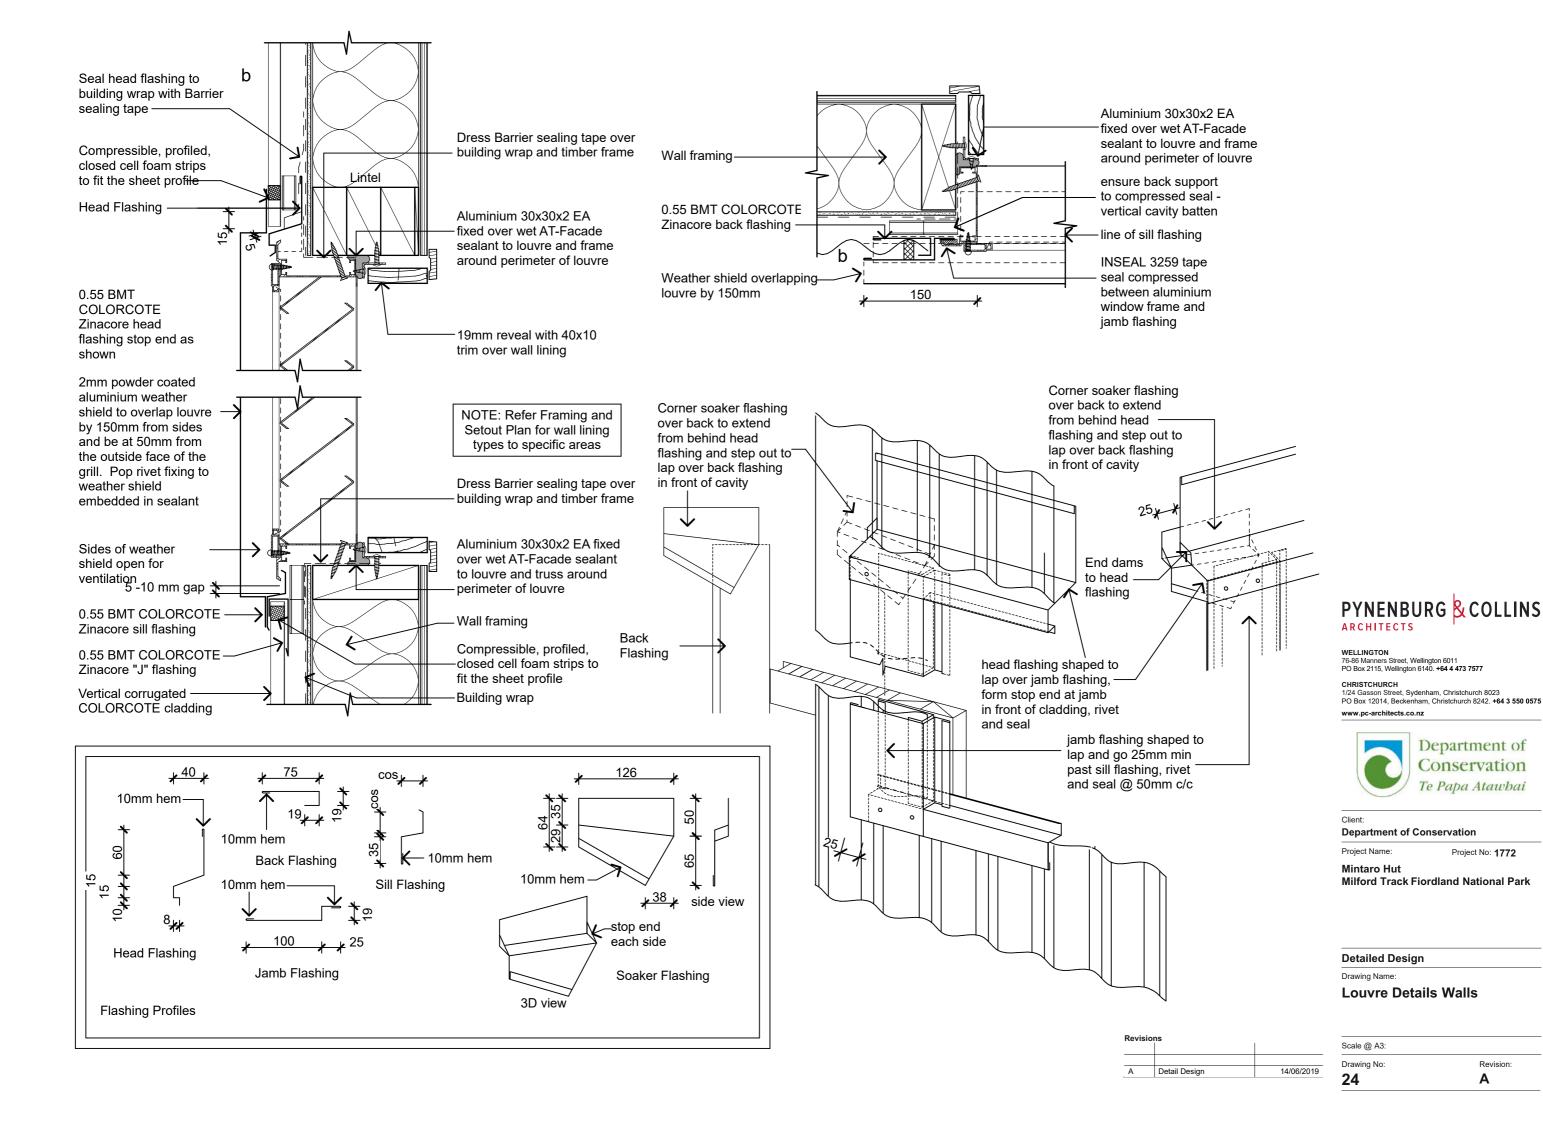

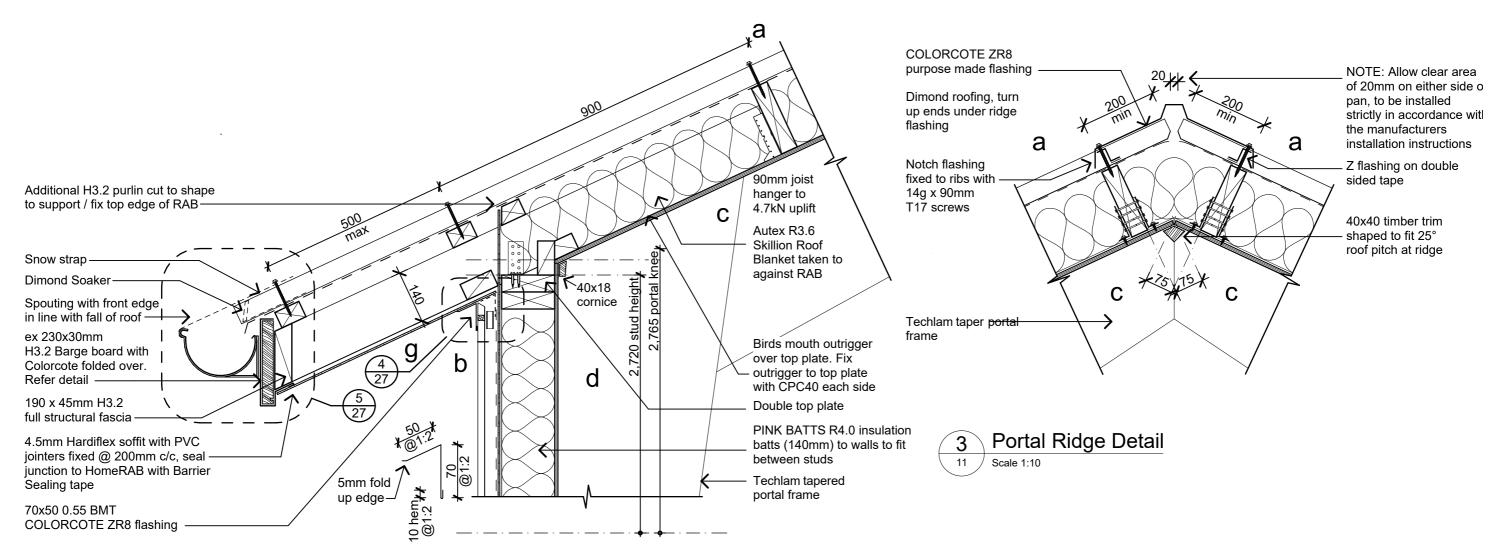



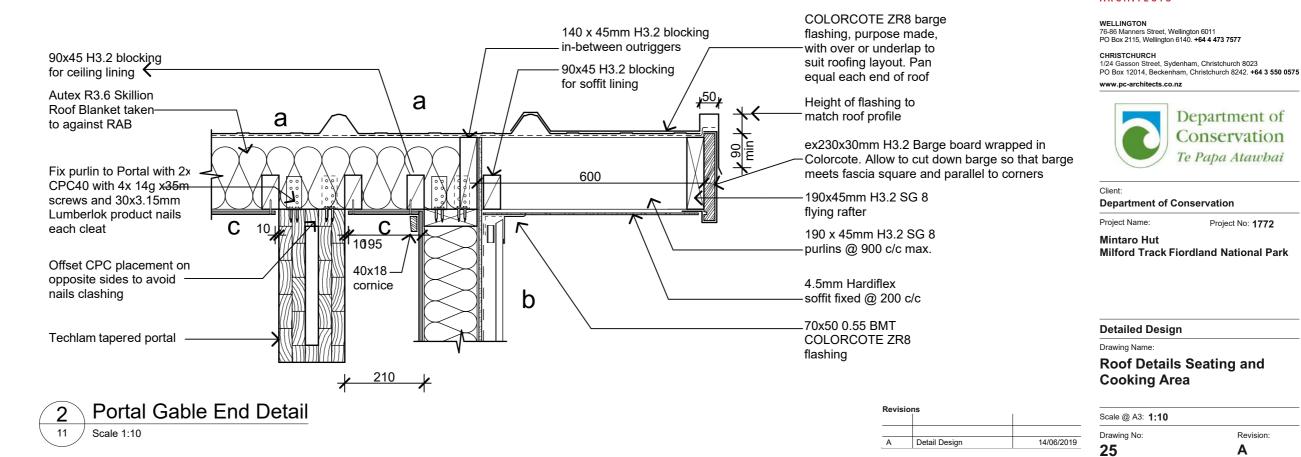

PYNENBURG & COLLINS

Department of


Conservation


Te Papa Atawbai


Project No: 1772

Revision:

Α

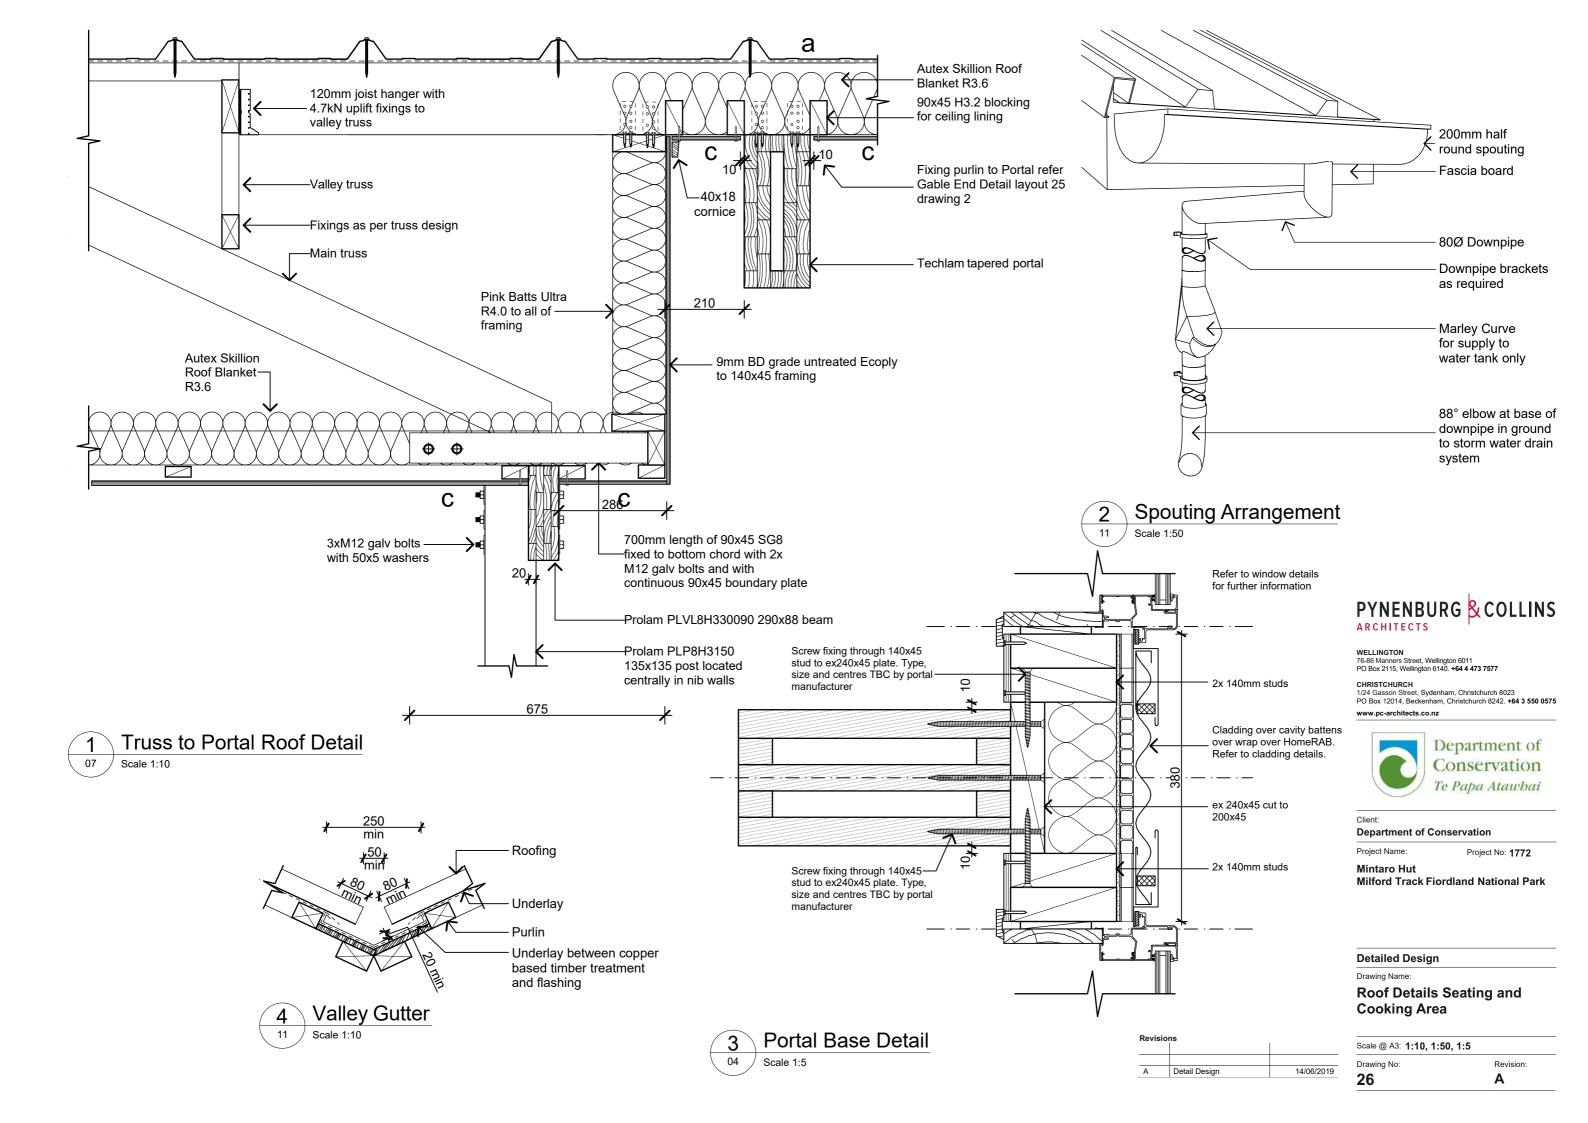

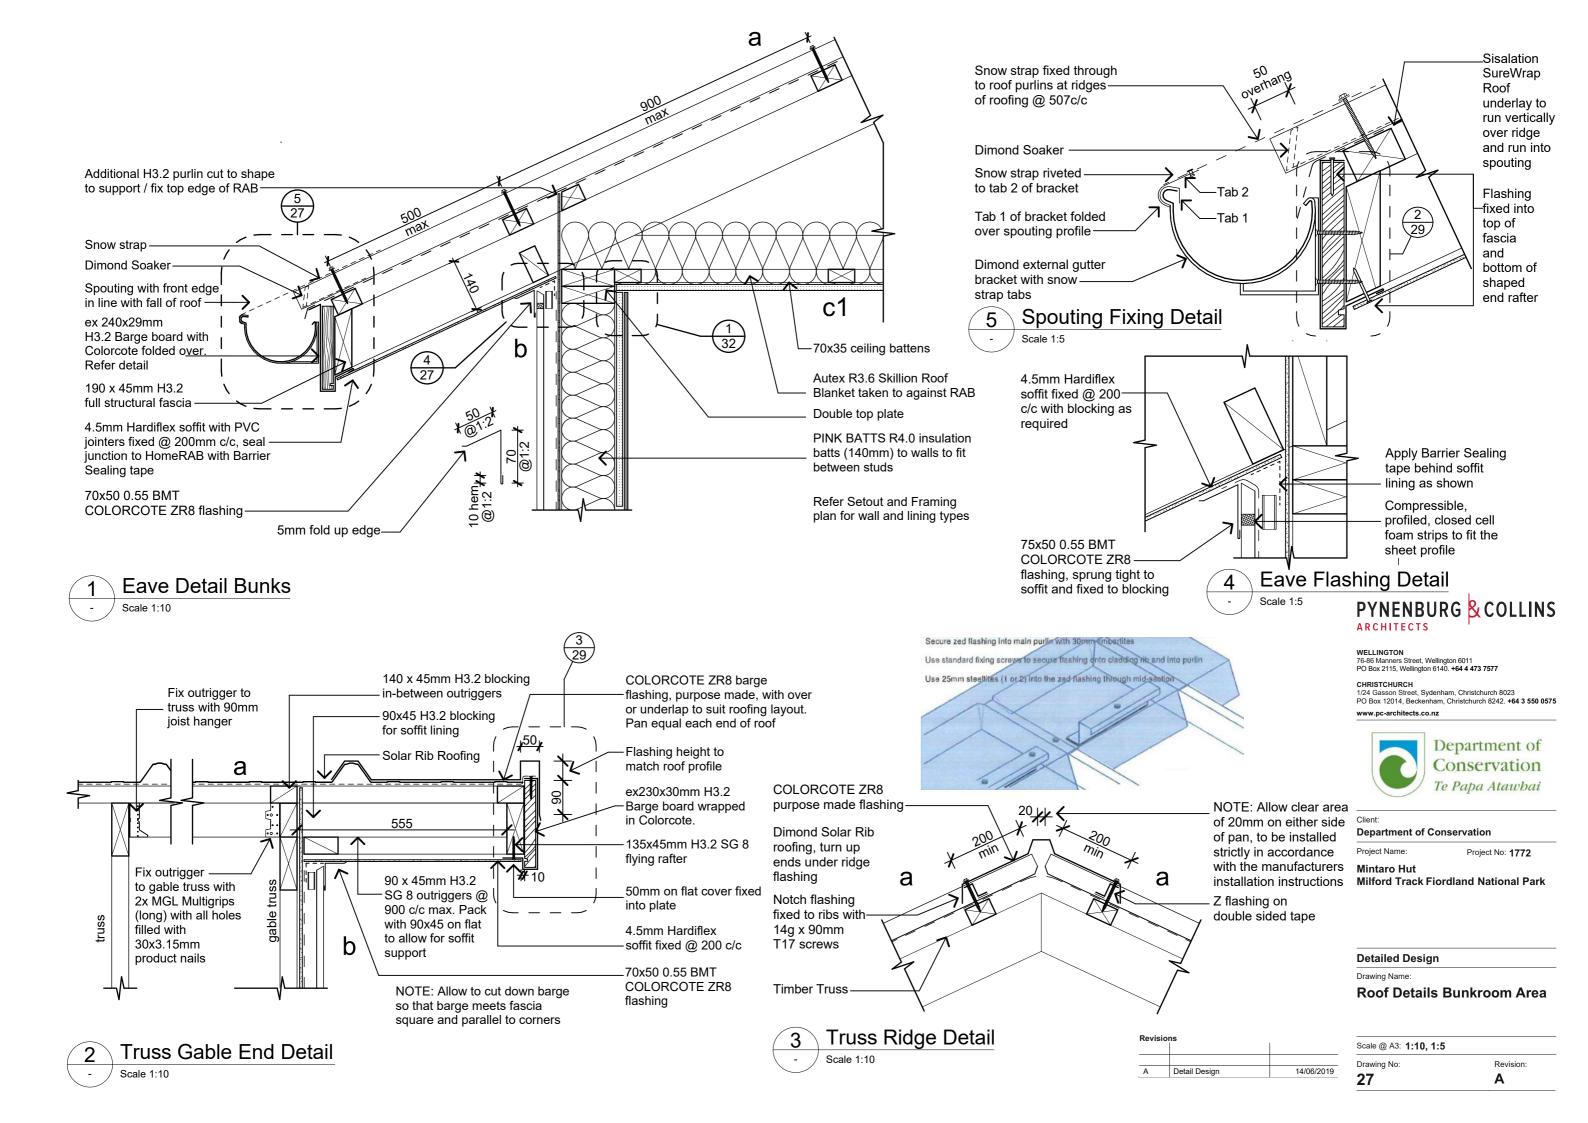

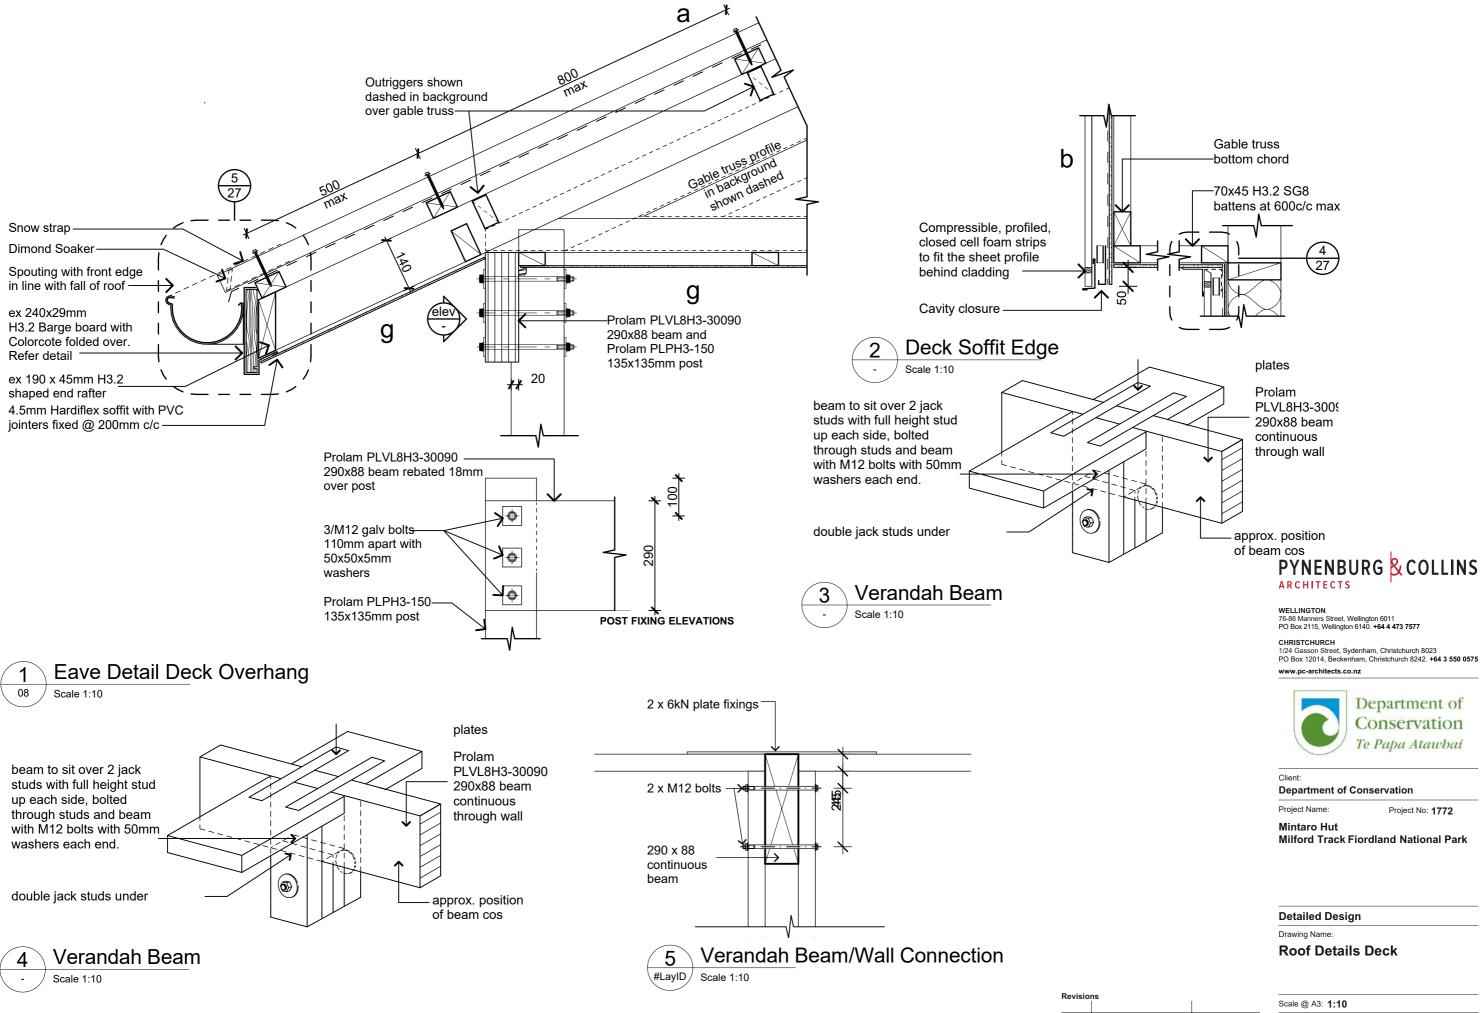


Scale @ A3: 1:10


Drawing No: Revision:


A

14/06/2019


Detail Design

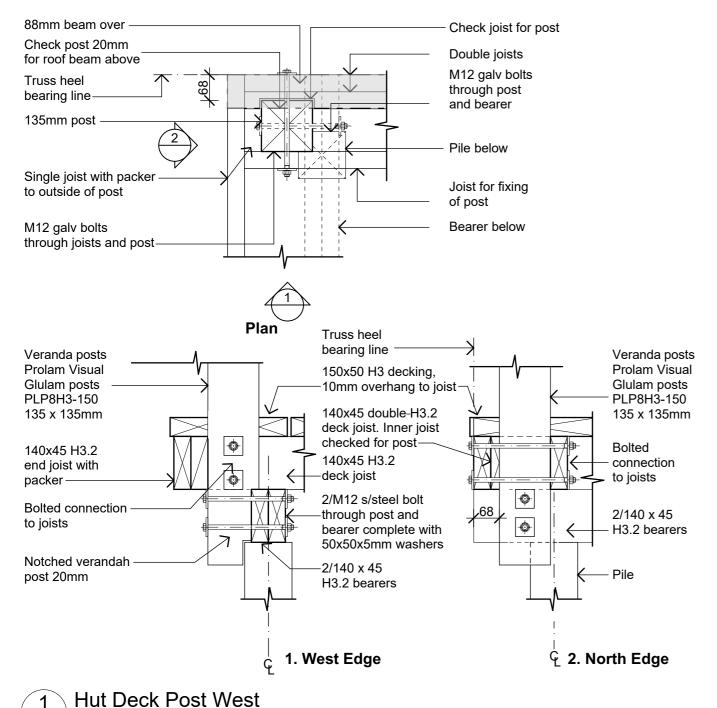

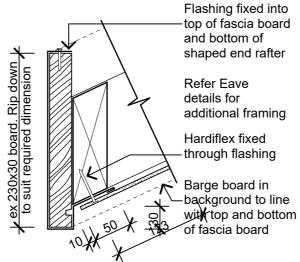

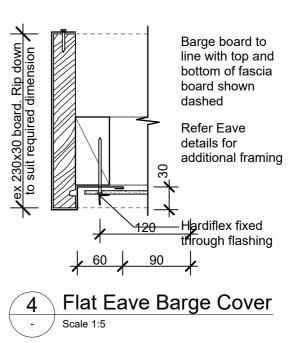

Raking Eave Barge Cover

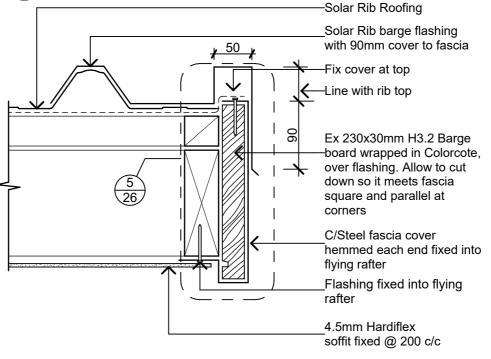

Barge Detail Scale 1:5



WELLINGTON 76-86 Manners Street, Wellington 6011 PO Box 2115, Wellington 6140. +64 4 473 7577

CHRISTCHURCH
1/24 Gasson Street, Sydenham, Christchurch 8023
PO Box 12014, Beckenham, Christchurch 8242. +64 3 550 0575 www.pc-architects.co.nz



Department of Conservation

Project Name:

Project No: 1772

Mintaro Hut

Milford Track Fiordland National Park


Detailed Design


Drawing Name:

Roof Details

Revisions		
Α	Detail Design	14/06/2019

Scale @ A3: 1:10, 1:5	
Drawing No:	Revision:
29	Α

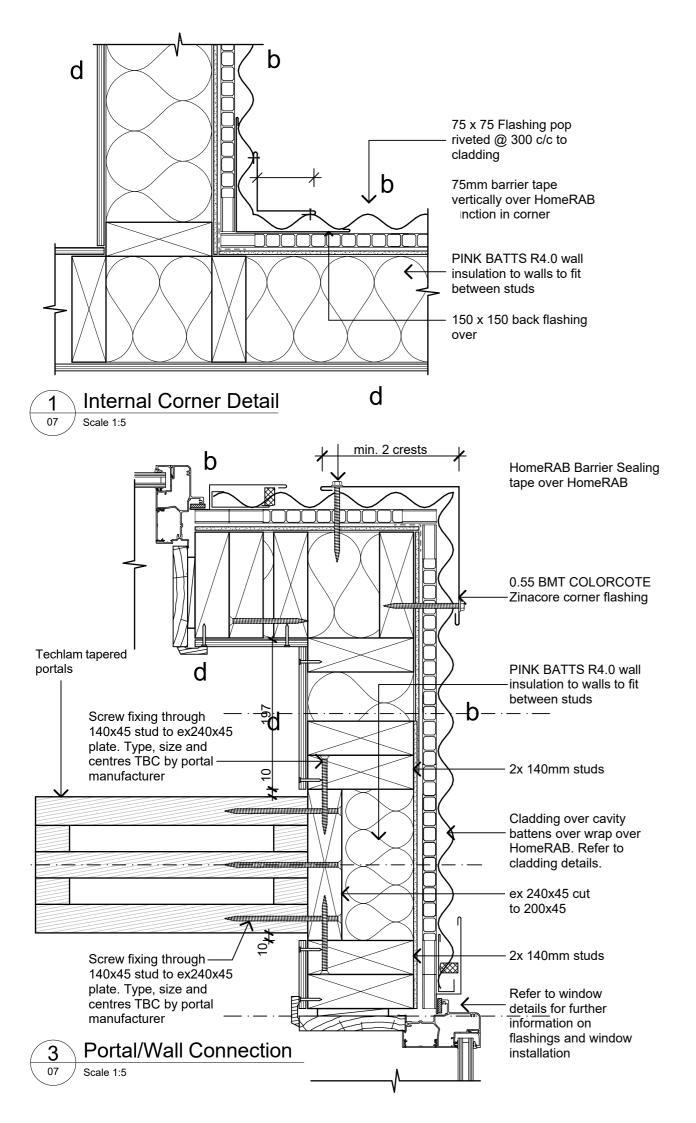

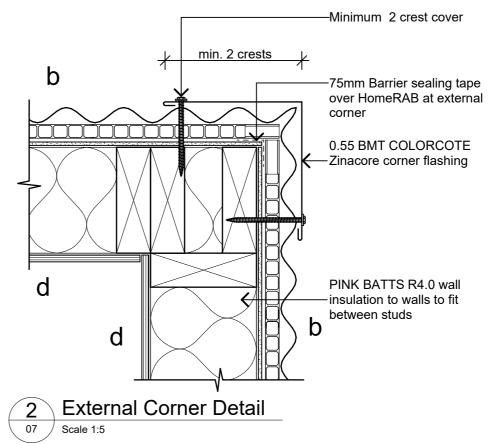

Material Notes:

- COLORCOTE Zinacore Dimond Solar Rib roofing over SISALATION SUREWRAP roofing underlay over 70 x 45 H3.2 purlins on flat @ 800c/c max. evenly spaced, with end purlins @ 500mm c/c. Refer specification for fixings of roofing and purlins.
- a2 COLORCOTE Zinacore Dimond Solar Rib roofing over SISALATION SUREWRAP roofing underlay over 190 x 45 H3.2 purlins on edge @ 900c/c max. evenly spaced, with end purlins @ 500mm c/c. Refer specification for fixings of roofing and
- COLORCOTE Zinacore 0.40 BMT CORRUGATE PROFILE cladding over cavity battens over Sisalation SureWrap wall underlay over 4.5mm HomeRAB Pre-Cladding board system over timber framing
- CHH 9mm ECOPLY BD grade untreated ceiling lining over 70 x 35 H1.2 battens @
- CHH 9mm ECOPLY BD grade untreated wall lining with 10mm gap to flooring.
- CHH 19mm ECOPLY CD grade H3.2 CCA 2400x1200 LS flooring over timber joists. Refer to foundation plan for sub floor framing
- 150x50 rough sawn H3.2 Radiata with top edges arised with webforge insert at doors Tensar SS20 Geogrid over exterior decking, fixed with stainless steel staples
- 4.5mm Hardiflex with PVC jointers
- CHH 9mm Ecoply BD grade untreated ply over 1 layer 10mm Gib Fyreline, with ply finished with Fireshield IFR clear intumescent coating
- $h2^{\,\text{CHH 9mm Ecoply BD grade untreated ply}}_{\,\,\text{over 1 layers 16mm Gib Fyreline, with ply}}$ finished with Fireshield IFR clear intumescent coating
- 1 layer 16mm Gib Fyreline

PYNENBURG & COLLINS **ARCHITECTS**

WELLINGTON 76-86 Manners Street, Wellington 6011 PO Box 2115, Wellington 6140. +64 4 473 7577

CHRISTCHURCH
1/24 Gasson Street, Sydenham, Christchurch 8023
PO Box 12014, Beckenham, Christchurch 8242. +64 3 550 0575 www.pc-architects.co.nz



Department of Conservation

Project Name:

Project No: 1772

Α

Mintaro Hut

Milford Track Fiordland National Park


Detailed Design

Drawing Name:


Wall Details

-		Scale @ A3: 1:5
		Drawing No:
	14/06/2019	20
		30

Detail Design

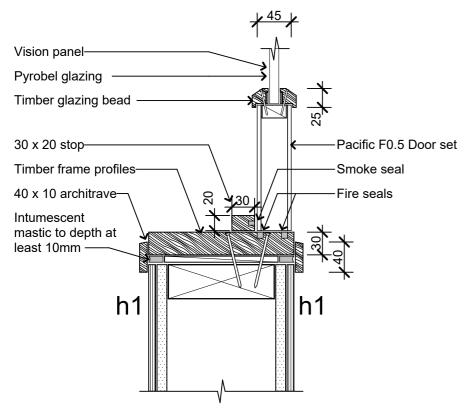



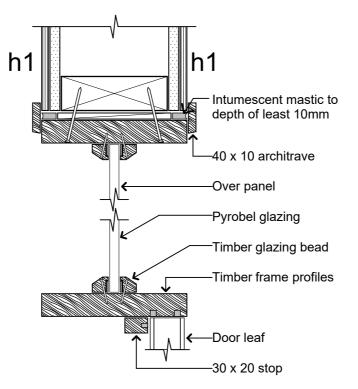

Fire Door Head Scale 1:5

Material Notes:

- COLORCOTE Zinacore Dimond Solar Rib roofing over SISALATION SUREWRAP roofing underlay over 70 x 45 H3.2 purlins on flat @ 800c/c max. evenly spaced, with end purlins @ 500mm c/c. Refer specification for fixings of roofing and purlins.
- a2 COLORCOTE Zinacore Dimond Solar Rib roofing over SISALATION SUREWRAP roofing underlay over 190 x 45 H3.2 purlins on edge @ 900c/c max. evenly spaced, with end purlins @ 500mm c/c. Refer specification for fixings of roofing and
- COLORCOTE Zinacore 0.40 BMT CORRUGATE PROFILE cladding over cavity battens over Sisalation SureWrap b wall underlay over 4.5mm HomeRAB Pre-Cladding board system over timber framing
- CHH 9mm ECOPLY BD grade untreated ceiling lining over 70 x 35 H1.2 battens @ C
- CHH 9mm ECOPLY BD grade untreated wall lining with 10mm gap to flooring.
- CHH 19mm ECOPLY CD grade H3.2 CCA 2400x1200 LS flooring over timber joists. Refer to foundation plan for sub floor framing sizes & c/c.
- 150x50 rough sawn H3.2 Radiata with top edges arised with webforge insert at doors Tensar SS20 Geogrid over exterior decking, fixed with stainless steel staples
- 4.5mm Hardiflex with PVC jointers
- CHH 9mm Ecoply BD grade untreated ply over 1 layer 10mm Gib Fyreline, with ply finished with Fireshield IFR clear intumescent coating
- h2 CHH 9mm Ecoply BD grade untreated ply over 1 layers 16mm Gib Fyreline, with ply finished with Fireshield IFR clear intumescent coating
- 1 layer 16mm Gib Fyreline

PYNENBURG & COLLINS ARCHITECTS

WELLINGTON 76-86 Manners Street, Wellington 6011 PO Box 2115, Wellington 6140. **+64 4 473 7577**

CHRISTCHURCH
1/24 Gasson Street, Sydenham, Christchurch 8023
PO Box 12014, Beckenham, Christchurch 8242. +64 3 550 0575 www.pc-architects.co.nz



Department of Conservation

Project Name:

Project No: 1772

Mintaro Hut

Milford Track Fiordland National Park


Detailed Design

Drawing Name:


Fire-Rated Door Details

Revision	Revisions		
. A	Detail Design	14/06/2019	


Scale @ A3: 1:5	
Drawing No:	Revision:
21	Δ

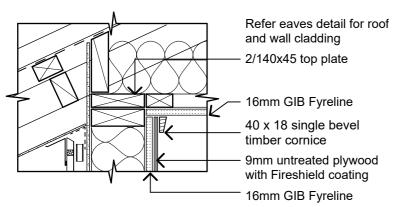


Wall to Ceiling Junction 30mins

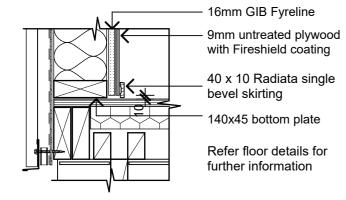

Floor to Wall Junction 30mins 16

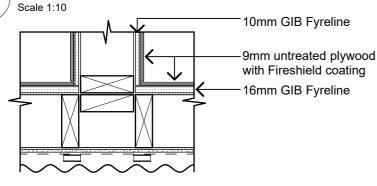


Wall to Wall Junction 30mins Scale 1:10

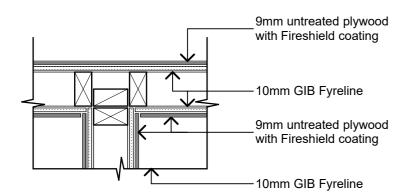

Inter-bunkroom to Lobby Scale 1:10


16mm GIB Fyreline 9mm untreated plywood with Fireshield coating 16mm GIB Fyreline

Wall Corner Junction 30mins 07 Scale 1:10

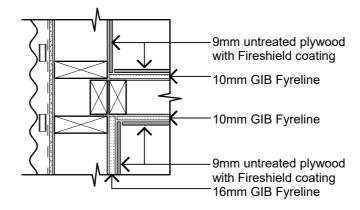

Wall Bunkroom 1 and 4 to Lobby Junction 30mins



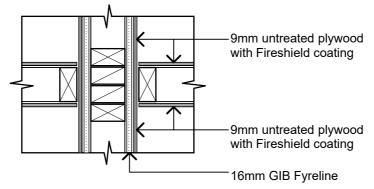

Wing Wall GIB Arrangement 07 Scale 1:10



WELLINGTON 76-86 Manners Street, Wellington 6011 PO Box 2115, Wellington 6140. +64 4 473 7577

CHRISTCHURCH
1/24 Gasson Street, Sydenham, Christchurch 8023
PO Box 12014, Beckenham, Christchurch 8242. +64 3 550 0575 www.pc-architects.co.nz



Department of Conservation

Project Name: Project No: 1772

Mintaro Hut

Milford Track Fiordland National Park


Detailed Design

Drawing Name:

Fire-Rated Details

Revision	Revisions		
Α	Detail Design	14/06/2019	

Scale @ A3: 1:10 Drawing No: Revision: 32 Α

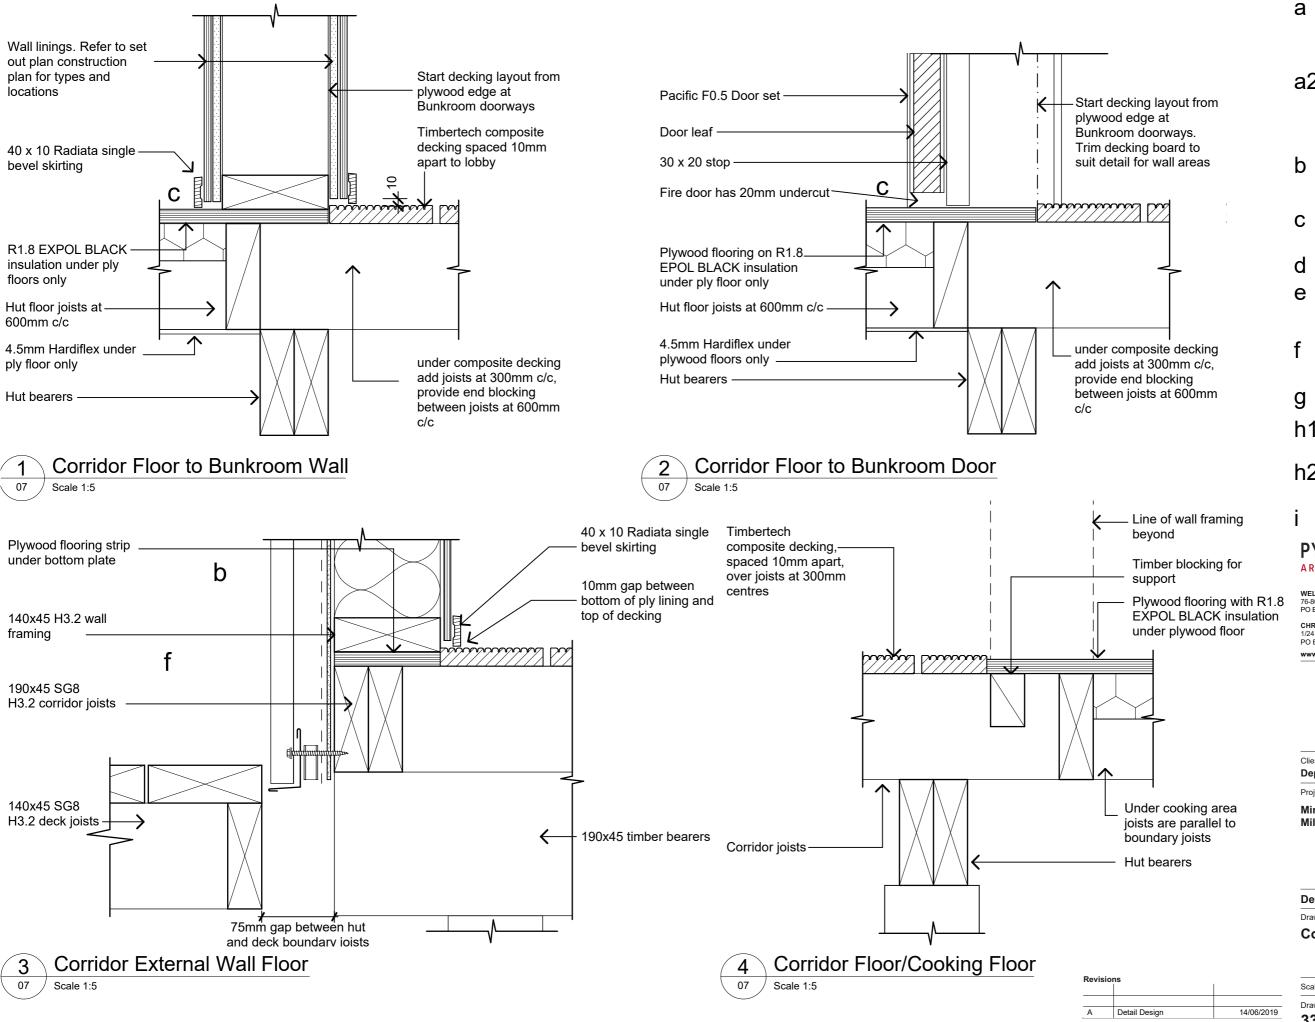

Material Notes:

COLORCOTE Zinacore Dimond Solar Rib roofing over SISALATION SUREWRAP roofing underlay over 70 x 45 H3.2 purlins on flat @ 800c/c max. evenly spaced, with end purlins @ 500mm c/c. Refer specification for fixings of roofing and purlins.

a2 COLORCOTE Zinacore Dimond Solar Rib roofing over SISALATION SUREWRAP roofing underlay over 190 x 45 H3.2 purlins on edge @ 900c/c max. evenly spaced, with end purlins @ 500mm c/c. Refer specification for fixings of roofing and

COLORCOTE Zinacore 0.40 BMT CORRUGATE PROFILE cladding over cavity battens over Sisalation SureWrap wall underlay over 4.5mm HomeRAB Pre-Cladding board system over timber framing

CHH 9mm ECOPLY BD grade untreated ceiling lining over 70 x 35 H1.2 battens @

CHH 9mm ECOPLY BD grade untreated wall lining with 10mm gap to flooring

CHH 19mm ECOPLY CD grade H3.2 CCA 2400x1200 LS flooring over timber joists. Refer to foundation plan for sub floor framing

150x50 rough sawn H3.2 Radiata with top edges arised with webforge insert at doors Tensar SS20 Geogrid over exterior decking,

4.5mm Hardiflex with PVC jointers

CHH 9mm Ecoply BD grade untreated ply over 1 layer 10mm Gib Fyreline, with ply finished with Fireshield IFR clear intumescent coating

h2 CHH 9mm Ecoply BD grade untreated ply over 1 layers 16mm Gib Fyreline, with ply finished with Fireshield IFR clear intumescent coating

1 layer 16mm Gib Fyreline

PYNENBURG & COLLINS ARCHITECTS

WELLINGTON

76-86 Manners Street, Wellington 6011 PO Box 2115, Wellington 6140. **+64 4 473 7577**

CHRISTCHURCH
1/24 Gasson Street, Sydenham, Christchurch 8023
PO Box 12014, Beckenham, Christchurch 8242. +64 3 550 0575 www.pc-architects.co.nz



Department of Conservation

Project Name: Project No: 1772

Mintaro Hut


Milford Track Fiordland National Park

Detailed Design

Drawing Name:

Corridor Floor Details


Scale @ A3: 1:5 Drawing No: Revision 33 Α

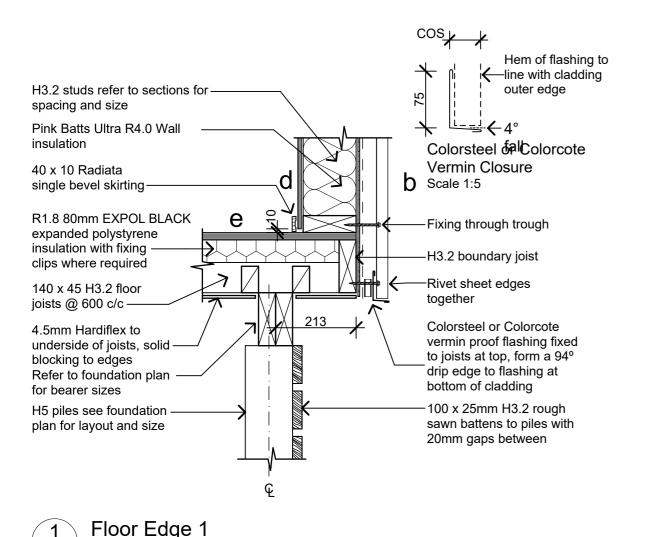


Scale 1:10

07

Scale 1:10

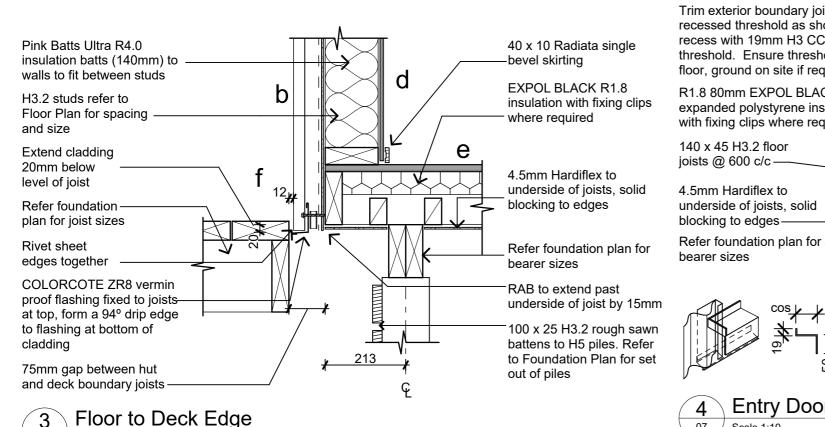

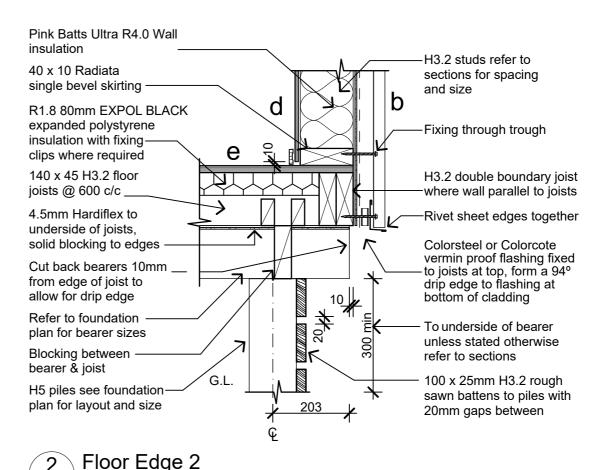

Trim exterior boundary joist to allow for recessed threshold as shown. Pack recess with 19mm H3 CCA Ply to support Folded and welded alum. threshold. Ensure threshold is flush with chequer plate threshold recessed into floor for floor, ground on site if required outward opening doors. R1.8 80mm EXPOL BLACK Bottom of door to be expanded polystyrene insulation 15mm below floor level with fixing clips where required 1200x900 Webforge 140 x 45 H3.2 floor Galvanised A325MSG joists @ 600 c/c serrated grating fixed to joists, packed to align with 4.5mm Hardiflex to top of decking underside of joists, solid

Scale 1:10

Entry Door Sill

Scale 1:10

07

Refer foundation plan for joist sizes

Material Notes:

- COLORCOTE Zinacore Dimond Solar Rib roofing over SISALATION SUREWRAP roofing underlay over 70 x 45 H3.2 purlins on flat @ 800c/c max. evenly spaced, with end purlins @ 500mm c/c. Refer specification for fixings of roofing and purlins.
- a2 COLORCOTE Zinacore Dimond Solar Rib roofing over SISALATION SUREWRAP roofing underlay over 190 x 45 H3.2 purlins on edge @ 900c/c max. evenly spaced, with end purlins @ 500mm c/c. Refer specification for fixings of roofing and
- COLORCOTE Zinacore 0.40 BMT CORRUGATE PROFILE cladding over cavity battens over Sisalation SureWrap wall underlay over 4.5mm HomeRAB Pre-Cladding board system over timber framing
- CHH 9mm ECOPLY BD grade untreated C ceiling lining over 70 x 35 H1.2 battens @
- CHH 9mm ECOPLY BD grade untreated wall lining with 10mm gap to flooring.
- CHH 19mm ECOPLY CD grade H3.2 CCA 2400x1200 LS flooring over timber joists. Refer to foundation plan for sub floor framing
- 150x50 rough sawn H3.2 Radiata with top edges arised with webforge insert at doors Tensar SS20 Geogrid over exterior decking, fixed with stainless steel staples
- 4.5mm Hardiflex with PVC jointers
- CHH 9mm Ecoply BD grade untreated ply over 1 layer 10mm Gib Fyreline, with ply finished with Fireshield IFR clear intumescent coating
- $h2^{\,\text{CHH 9mm Ecoply BD grade untreated ply}}_{\,\text{over 1 layers 16mm Gib Fyreline, with ply}}$ finished with Fireshield IFR clear intumescent coating
- 1 layer 16mm Gib Fyreline

PYNENBURG & COLLINS ARCHITECTS

WELLINGTON 76-86 Manners Street, Wellington 6011 PO Box 2115, Wellington 6140. **+64 4 473 7577**

CHRISTCHURCH
1/24 Gasson Street, Sydenham, Christchurch 8023
PO Box 12014, Beckenham, Christchurch 8242. +64 3 550 0575 www.pc-architects.co.nz



Department of Conservation

Project Name: Project No: 1772

Mintaro Hut

Milford Track Fiordland National Park

Detailed Design

Drawing Name:

Deck / Floor Edge Details

sio			
SIO			Scale @ A3: 1
			Drawing No:
	Detail Design	14/06/2019	Drawing No.


34


1:10 Revision Α

FACE FIXED BALUSTER POSTS




- Complies with Table 3.3 AS/NZS 1170.1:2002 for horizontal load of 0.75kN/m on handrail
- All fixings are designed to provide adequate rotational stability to the handrail system to resist the horizontal load at top of baluster post
- Assumes an approved post and balustrade system is used

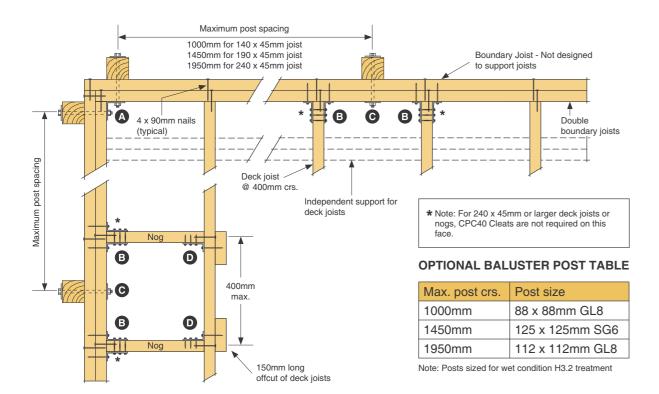

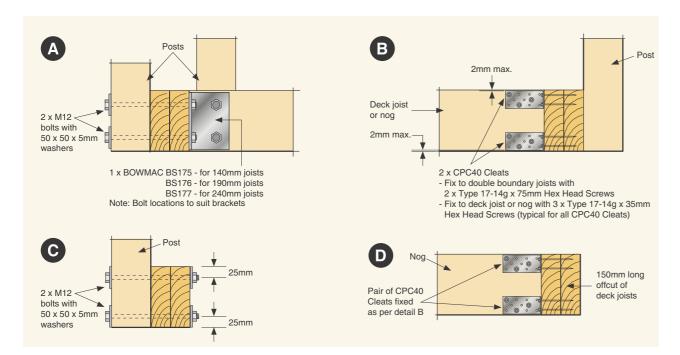



© Copyright 2018 MiTek Holdings, Inc. All rights reserved.

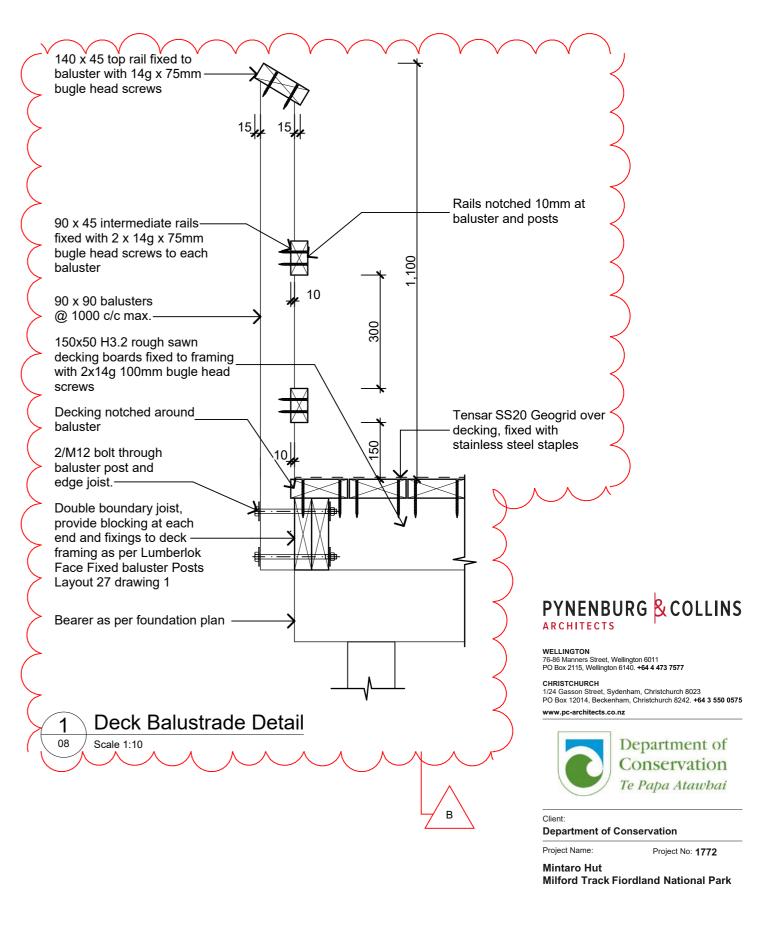

Detailed Design

Drawing Name:

Deck Details


Revisions	


В	Structure & Details	6/09/2019
Α	Detail Design	14/06/2019

 Scale @ A3: 1:10, 1:10.7078


 Drawing No:
 Revision:

 35
 B

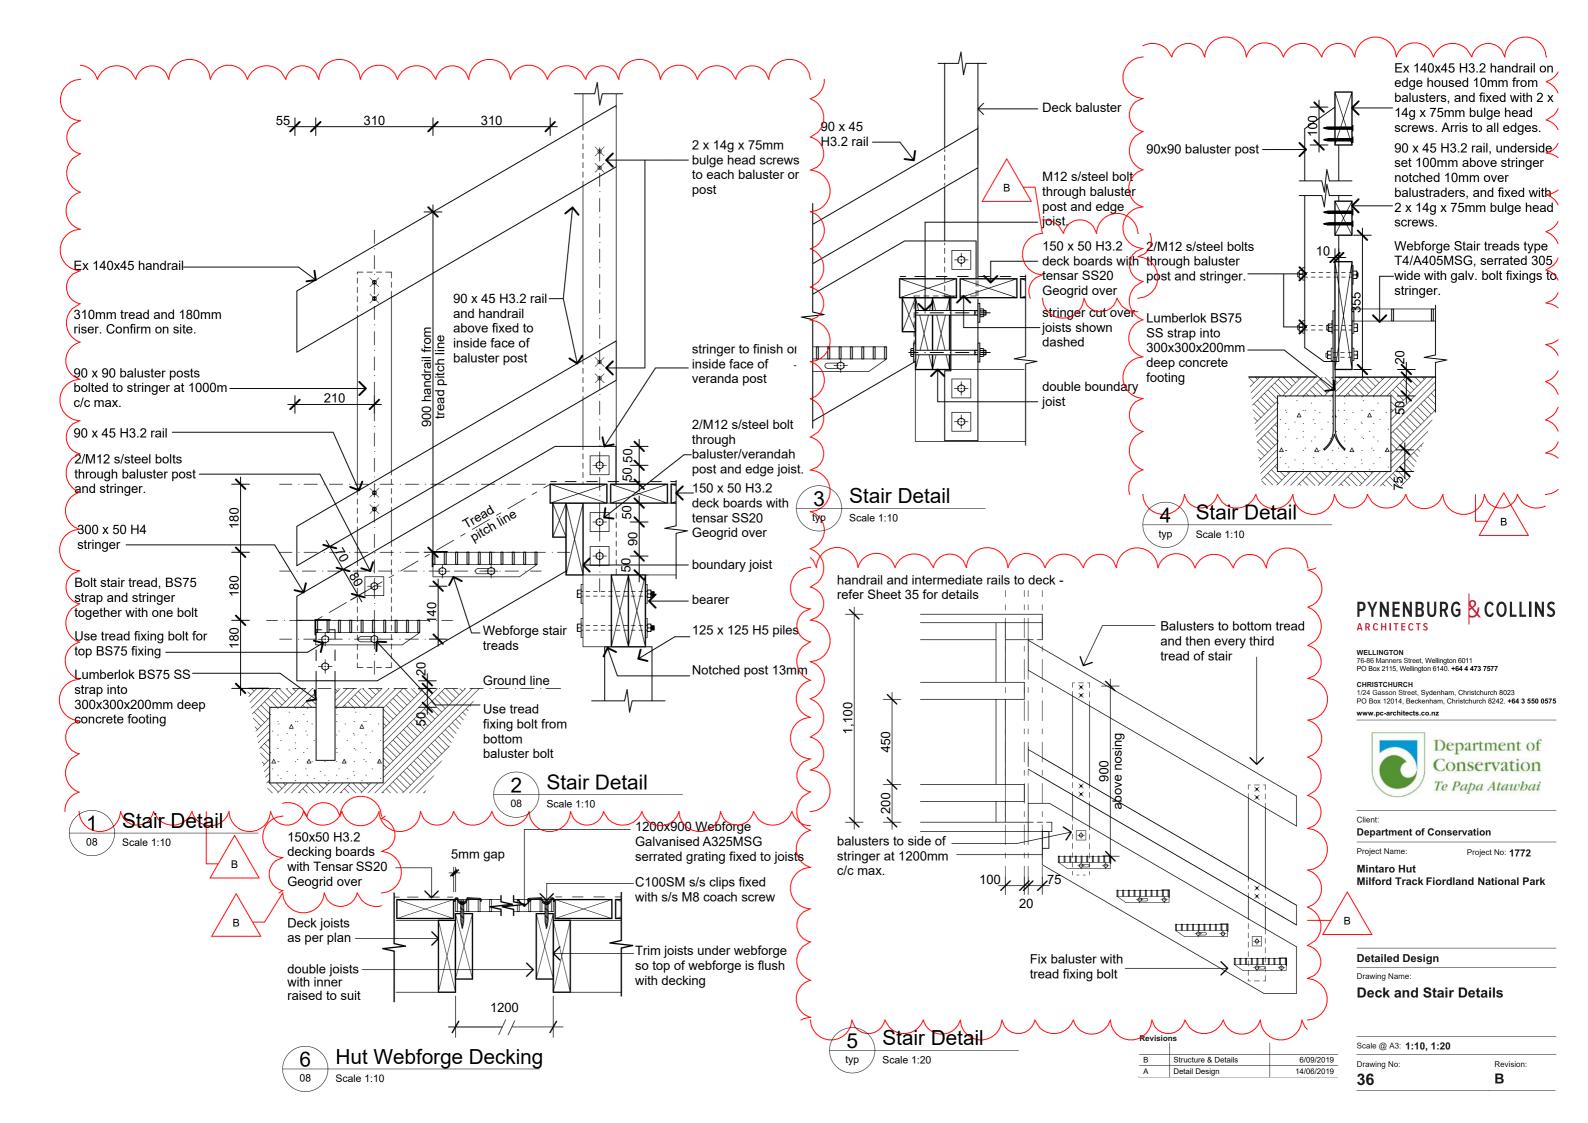


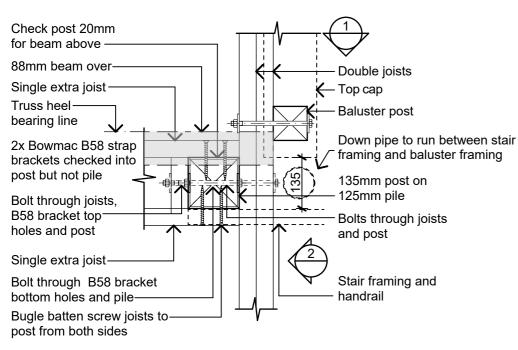


Plan

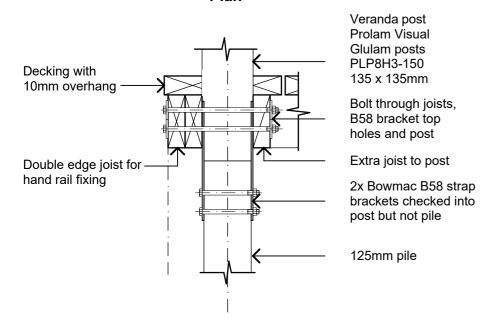


1. Balustrade edge

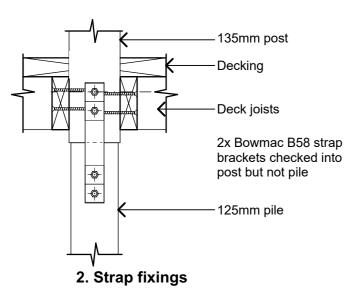

Hut Deck Post East Connection Scale 1:10

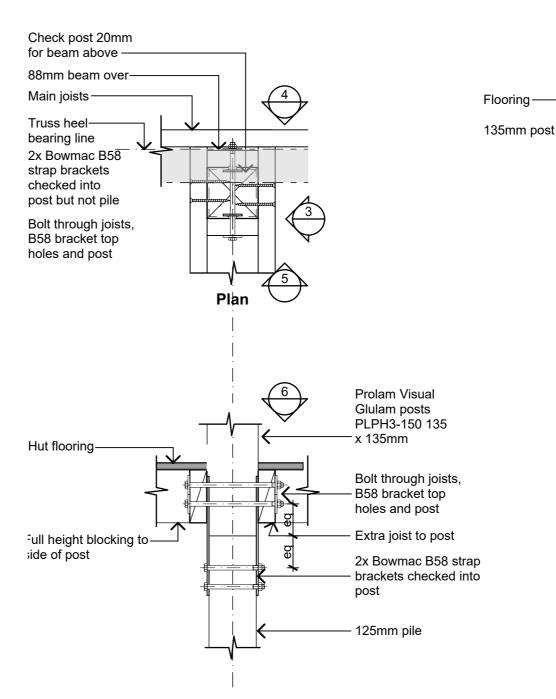

3. North South

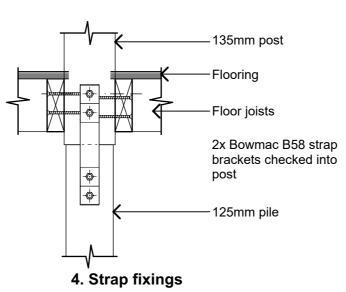

Cooking Post Connection Scale 1:10



WELLINGTON 76-86 Manners Street, Wellington 6011 PO Box 2115, Wellington 6140. +64 4 473 7577

CHRISTCHURCH
1/24 Gasson Street, Sydenham, Christchurch 8023
PO Box 12014, Beckenham, Christchurch 8242. +64 3 550 0575 www.pc-architects.co.nz



Department of Conservation

Project Name: Project No: 1772

Mintaro Hut

Milford Track Fiordland National Park

Detailed Design

Drawing Name:

Post Connections

Detail Design


Lobby


5. Wall base

6. Wall lining

Cooking

Scale @ A3: 1:10 Drawing No: Revision: 37 Α

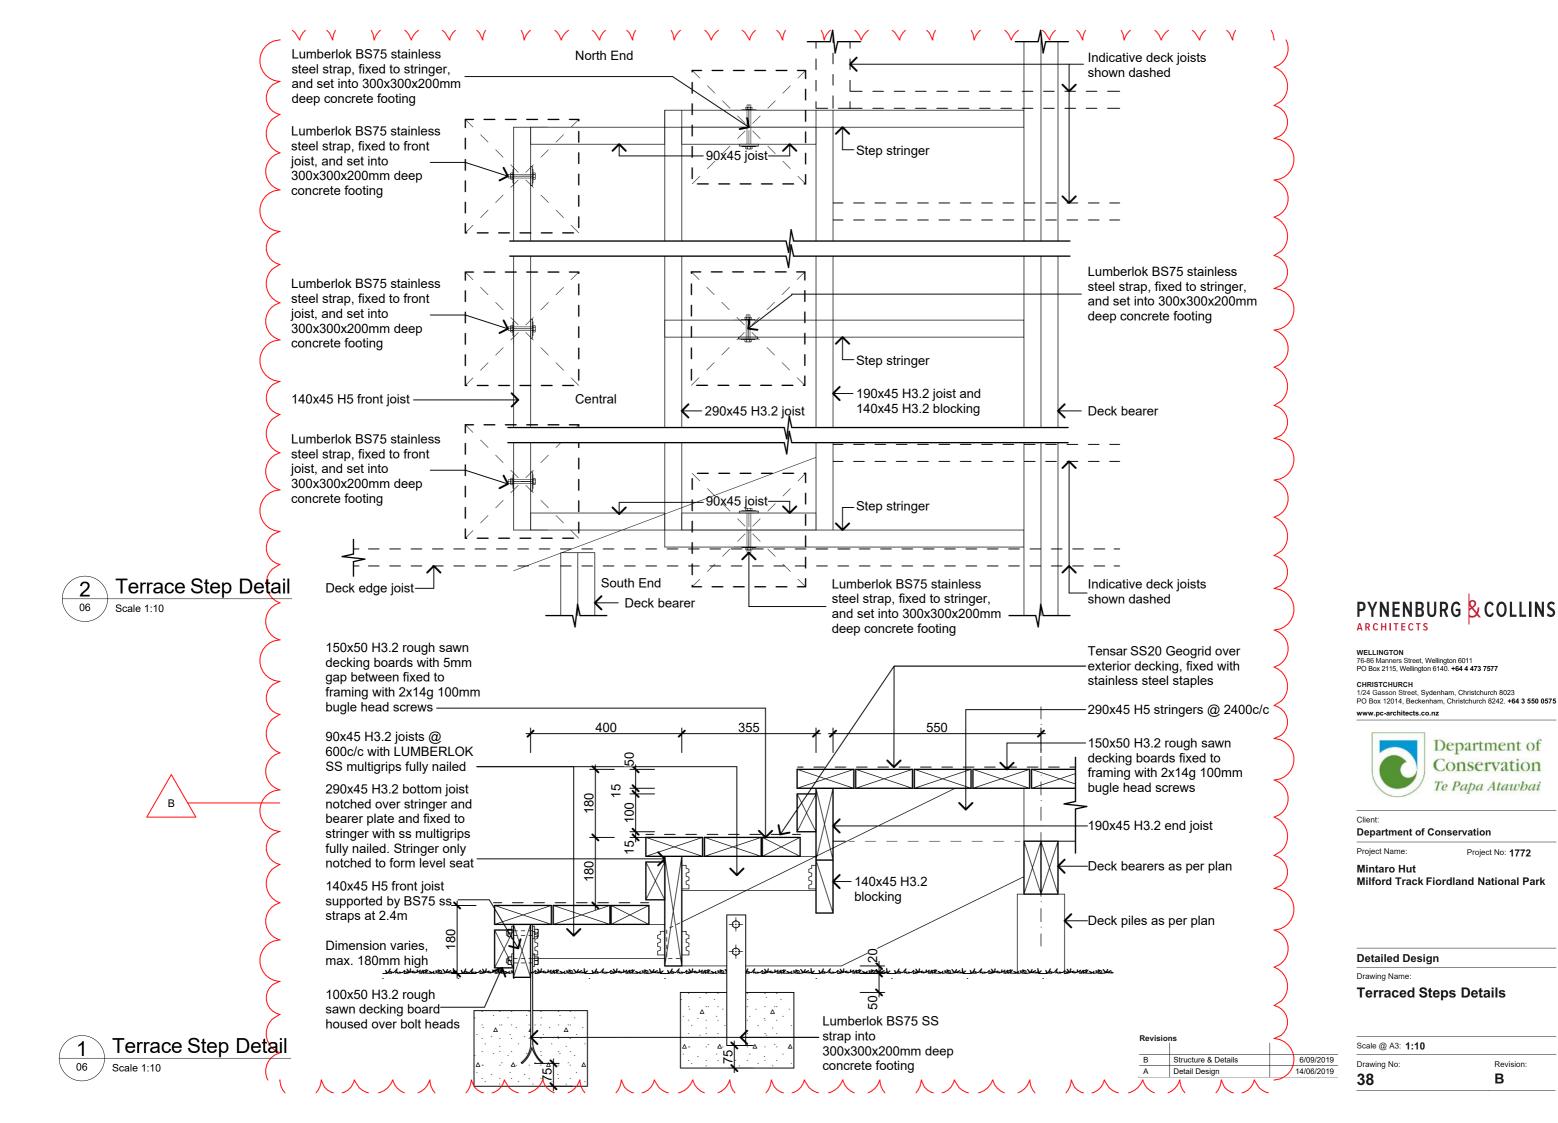

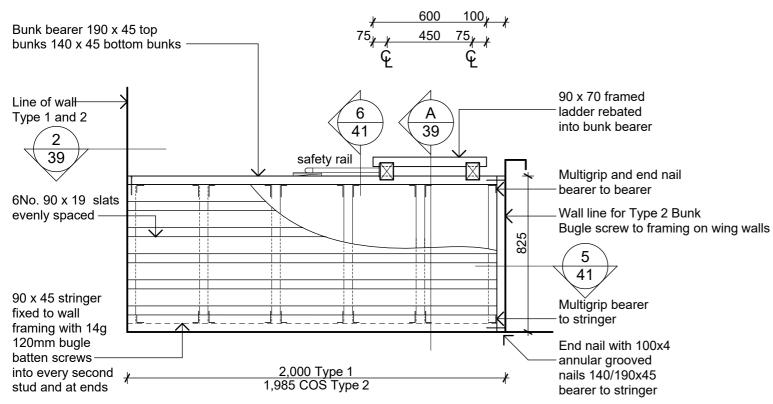

Top bunk bearer 190 x 45

70 x 45 rungs rebated 20mm

edges well arised and rounded

90 x 70 ladder posts rebated 20mm over bearer. All

rounded. Fix 190 x 45 & 140

x 45 rails to ladder posts with 2x14g 100mm bugle

edges well arised and

batten screws


-140 x 45

Bottom bunk bearer

double dwang under

ladder posts skew nail each post to dwangs

into posts fixed with 1x14g 100mm bugle batten screws. All

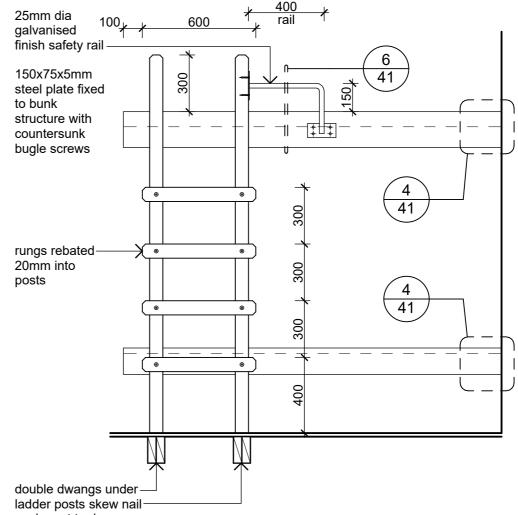

each post to dwangs Individual Bunk Elevation Type 1 (Type 2 sim) Scale 1:20

NOTE:

All timber framing to bunks shall be untreated Radiata clears D4S

PYNENBURG & COLLINS **ARCHITECTS**

WELLINGTON 76-86 Manners Street, Wellington 6011 PO Box 2115, Wellington 6140. +64 4 473 7577

CHRISTCHURCH
1/24 Gasson Street, Sydenham, Christchurch 8023
PO Box 12014, Beckenham, Christchurch 8242. +64 3 550 0575 www.pc-architects.co.nz



Department of Conservation

Project Name: Project No: 1772

Mintaro Hut


Milford Track Fiordland National Park

Detailed Design

Drawing Name:

Individual Bunk Type 1 and 2

Scale @ A3: 1:20, 1:200 Revision: 39 Α

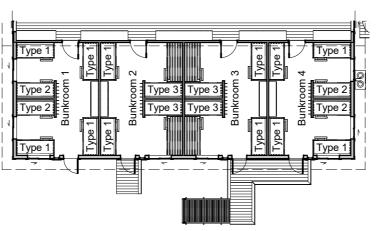




Typical Individual Bunk Section Scale 1:20


Individual Bunk Plan Type 1 (Type 2 sim)

41

41


Detail Design

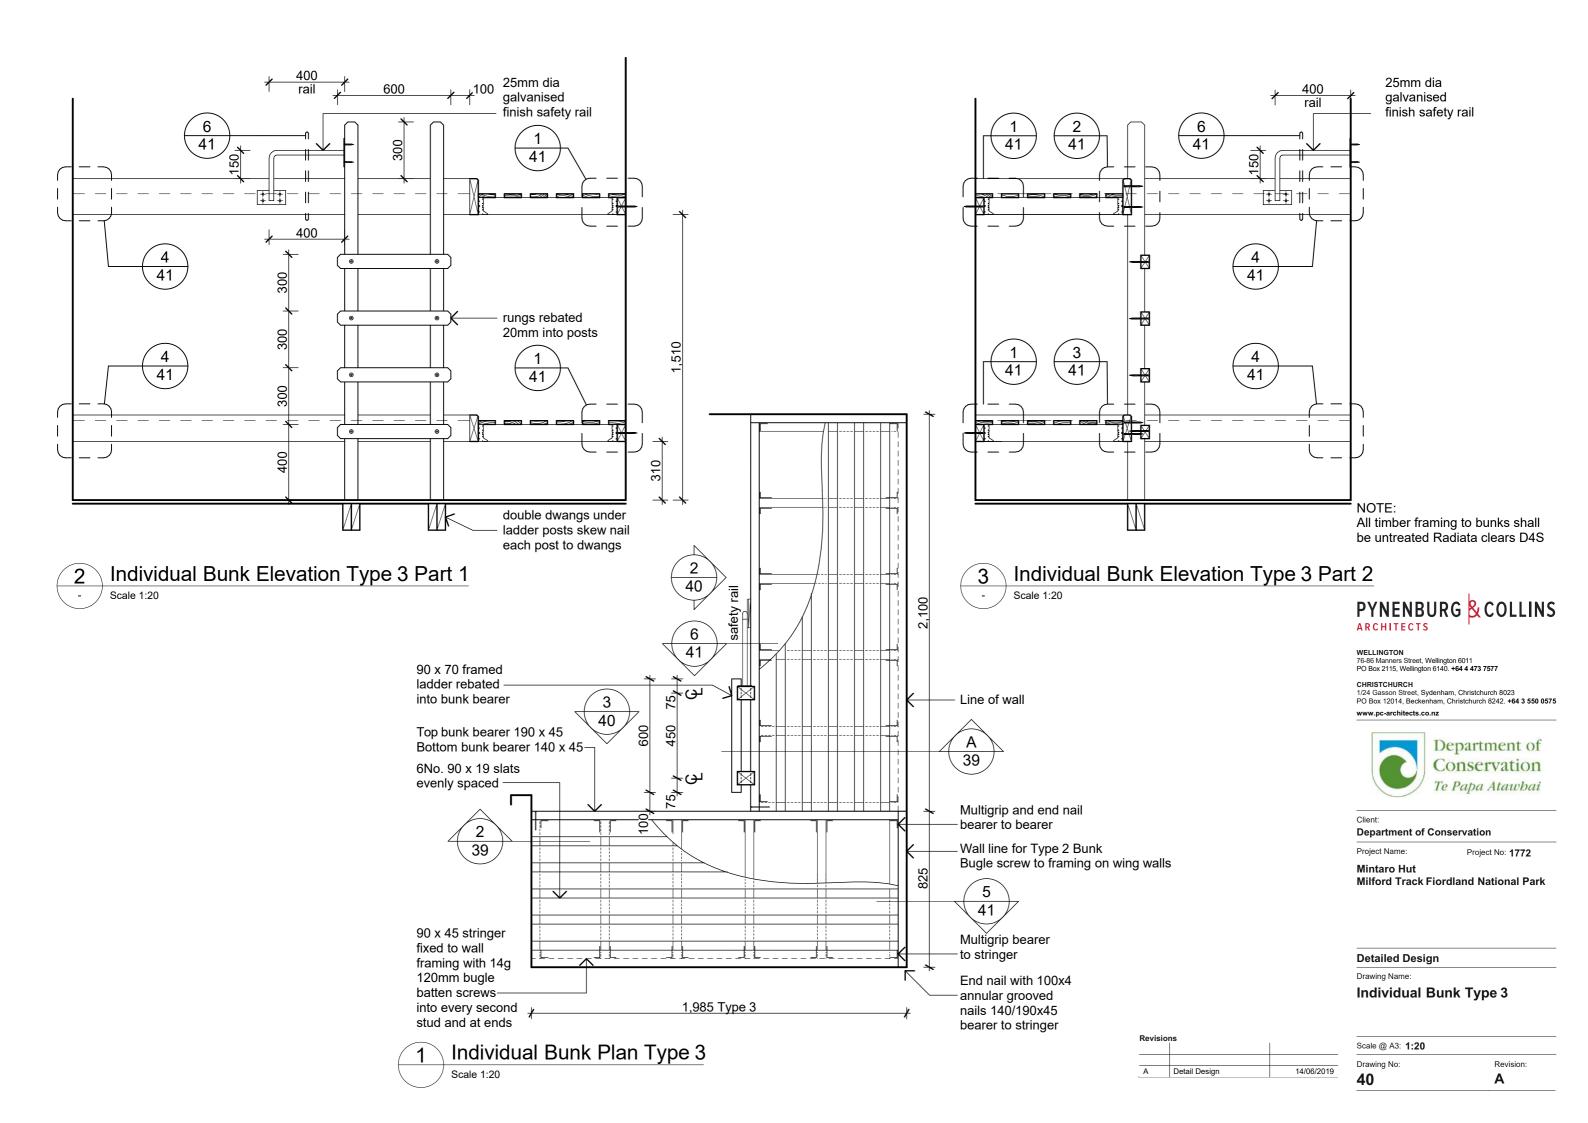


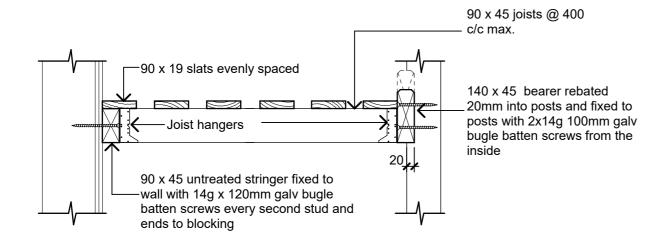


Stringer to Wall Connection

Bunk Beam to Ladder Upper Scale 1:10

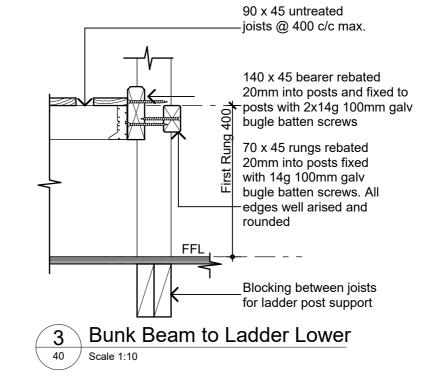


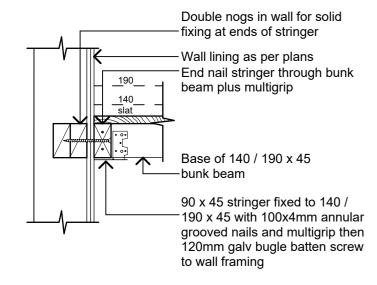



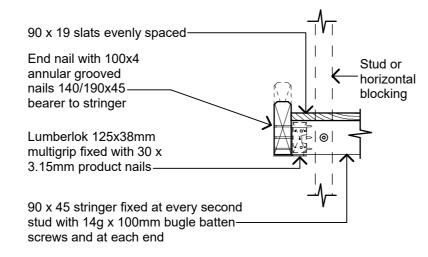



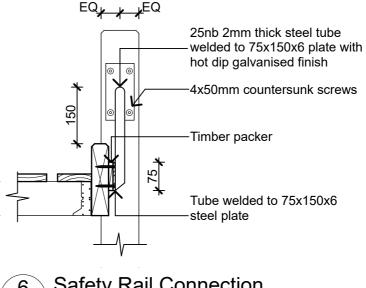

Safety Rail Connection Scale 1:10

NOTE:

All timber framing to bunks shall be untreated Radiata clears D4S

PYNENBURG & COLLINS ARCHITECTS

WELLINGTON 76-86 Manners Street, Wellington 6011 PO Box 2115, Wellington 6140. +64 4 473 7577

CHRISTCHURCH
1/24 Gasson Street, Sydenham, Christchurch 8023
PO Box 12014, Beckenham, Christchurch 8242. +64 3 550 0575 www.pc-architects.co.nz



Department of Conservation

Project Name:

Project No: 1772

Mintaro Hut

Milford Track Fiordland National Park


Detailed Design


Drawing Name:

Individual Bunk Details

Revis	ions		
10110			Scale @ A3: 1:10
			Drawing No:
Α	Detail Design	14/06/2019	AA °
		•	41

Revision: Α

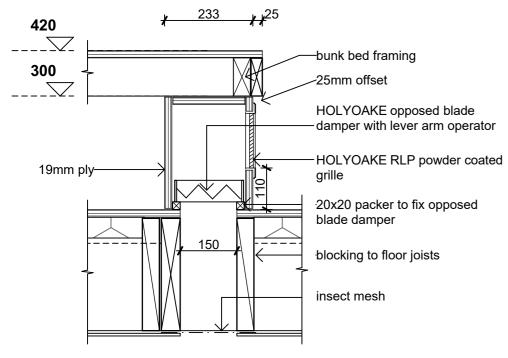

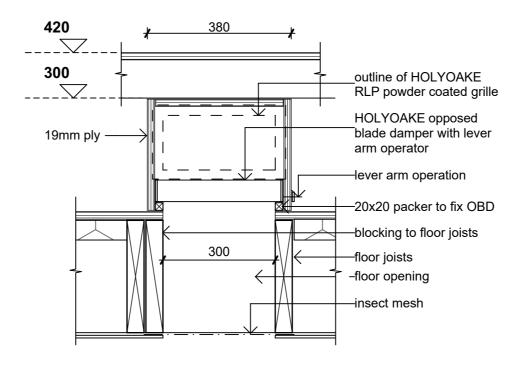





WELLINGTON 76-86 Manners Street, Wellington 6011 PO Box 2115, Wellington 6140. +64 4 473 7577

CHRISTCHURCH
1/24 Gasson Street, Sydenham, Christchurch 8023
PO Box 12014, Beckenham, Christchurch 8242. +64 3 550 0575

www.pc-architects.co.nz



Department of Conservation

Project Name: Project No: 1772

Mintaro Hut

Milford Track Fiordland National Park


Detailed Design


Drawing Name:

Floor Vents


Scale @ A3: 1:10	
Drawing No:	Revision:
42	Α

Floor Ventilation Box Details Scale 1:10

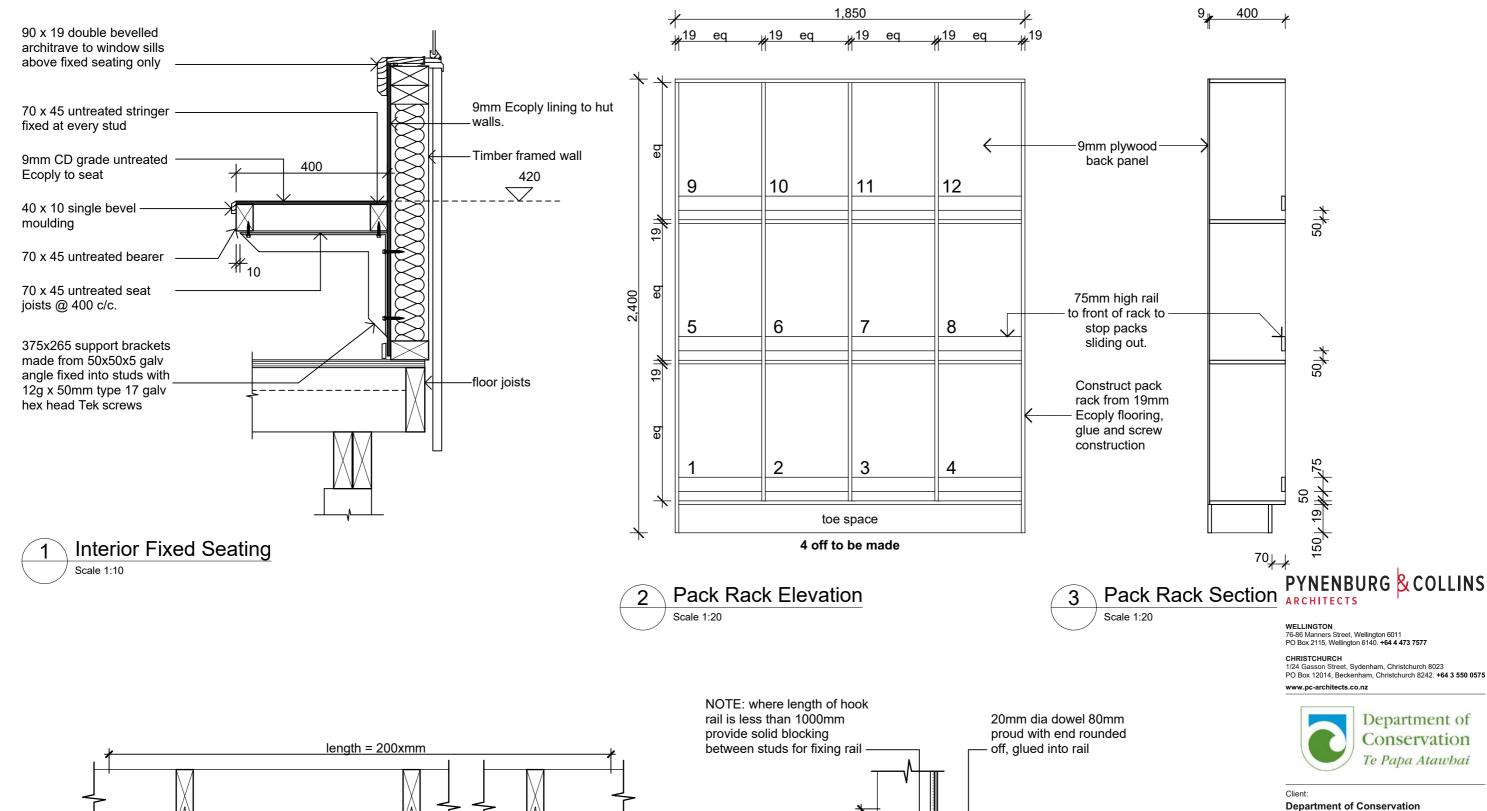

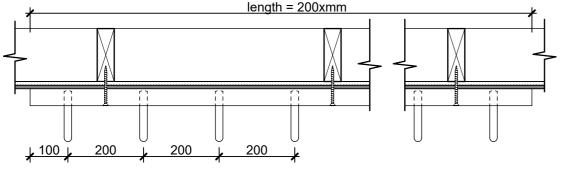



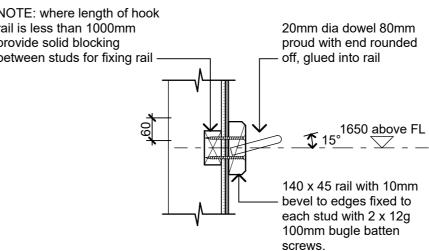

Coat Hooks -Section Scale 1:10

Revisions		
	Detail Design	14/06/2019

Project Name: Project No: 1772

Mintaro Hut


Milford Track Fiordland National Park

Detailed Design


Drawing Name:

Fixed Seating Pack Rack Coat Hooks Details


Scale @ A3: 1:10, 1:20	
Drawing No:	Revision
1 3	Δ

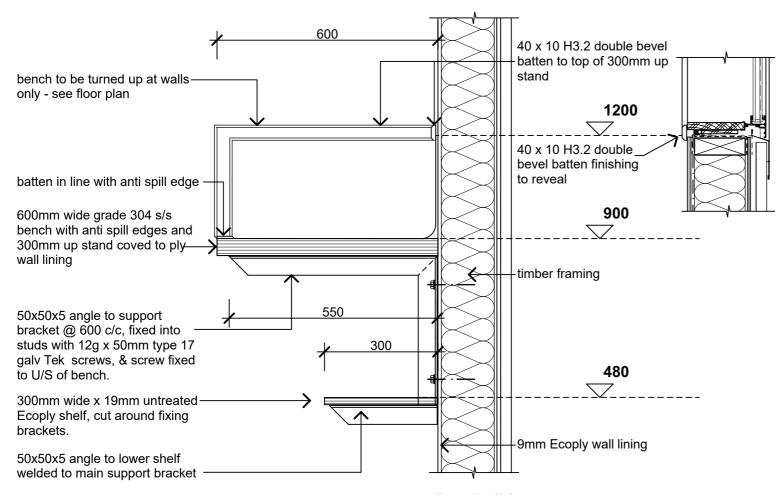

Cooking Bench Section

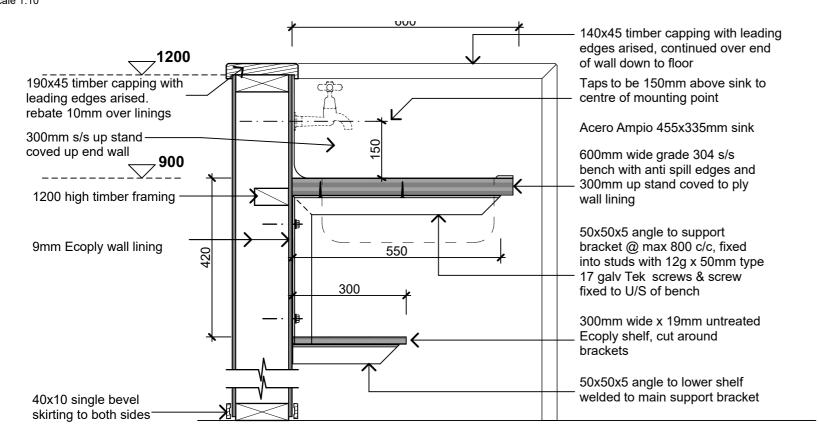

Cooking Bench Section Part Height Wall

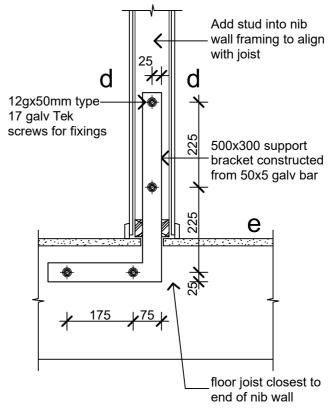

NOTE: - Tight slot cut in bottom plate and flooring - under floor insulation to fit tight against bracket(insulation not

Nib Wall Fixing Bracket Detail

shown for clarity)

Scale 1:10



WELLINGTON 76-86 Manners Street, Wellington 6011 PO Box 2115, Wellington 6140. +64 4 473 7577

CHRISTCHURCH
1/24 Gasson Street, Sydenham, Christchurch 8023
PO Box 12014, Beckenham, Christchurch 8242. +64 3 550 0575 www.pc-architects.co.nz



Department of Conservation

Project Name:

Project No: 1772

Mintaro Hut

Milford Track Fiordland National Park


Detailed Design

Drawing Name:


Cooking Area Details

Detail Design

Scale @ A3: 1:10 Drawing No: Α

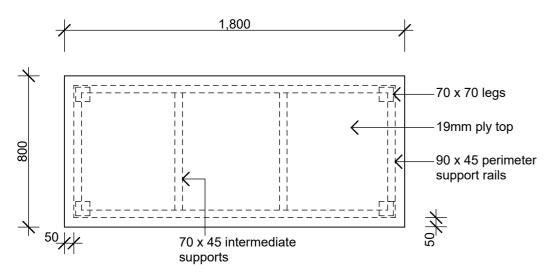



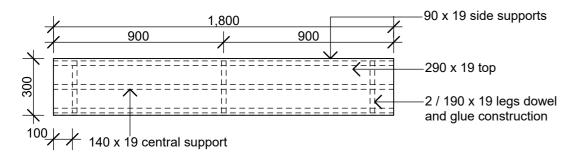





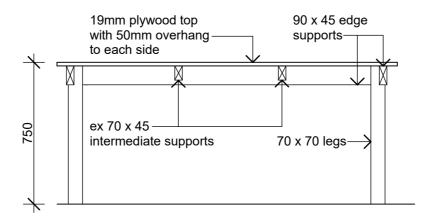


Table Section Scale 1:20



Form Section Scale 1:20

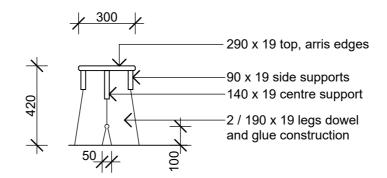

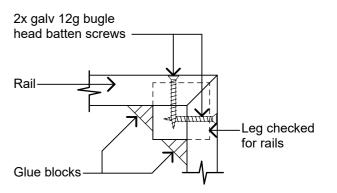



WELLINGTON 76-86 Manners Street, Wellington 6011 PO Box 2115, Wellington 6140. +64 4 473 7577

CHRISTCHURCH
1/24 Gasson Street, Sydenham, Christchurch 8023
PO Box 12014, Beckenham, Christchurch 8242. +64 3 550 0575 www.pc-architects.co.nz



Department of Conservation

Project Name:

Project No: 1772

Mintaro Hut Milford Track Fiordland National Park

Detailed Design

Drawing Name:


Tables and Forms

Revisions				

A Detail Design


	Scale @ A3: 1:2
14/06/2019	Drawing No:
14/06/2019	4 =

20, 1:5 Revision: 45 Α

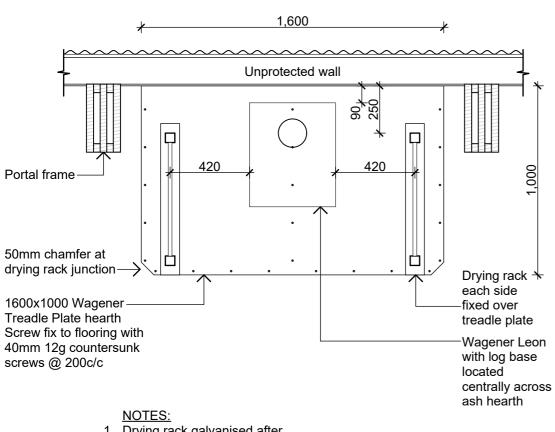

1. Drying rack galvanised after fabrication

Hut Wood Burner Details

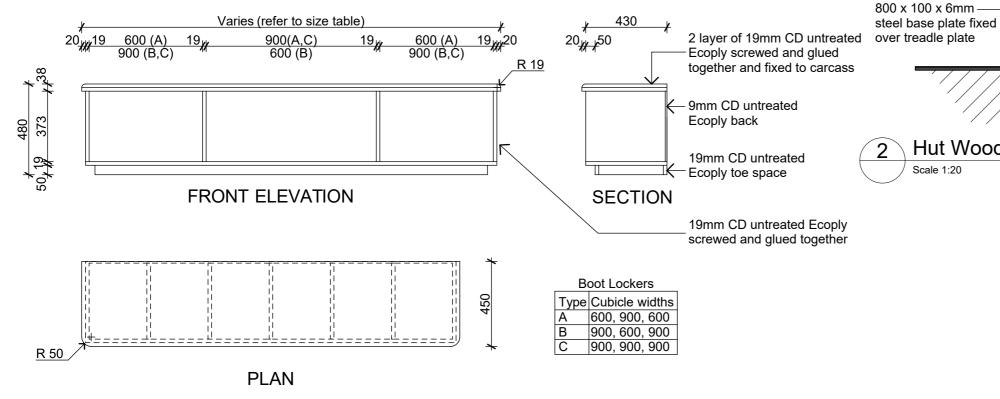

PYNENBURG & COLLINS ARCHITECTS

WELLINGTON 76-86 Manners Street, Wellington 6011 PO Box 2115, Wellington 6140. +64 4 473 7577

CHRISTCHURCH
1/24 Gasson Street, Sydenham, Christchurch 8023
PO Box 12014, Beckenham, Christchurch 8242. +64 3 550 0575 www.pc-architects.co.nz



Department of Conservation

Project Name: Project No: 1772

Mintaro Hut

Milford Track Fiordland National Park

Detailed Design

Drawing Name:

Woodburner Drying Rack Boot Lockers

Revision:

В

	Scale @ A3: 1:20
09/2019	Drawing No:
06/2019	~
	46

Boot Lockers Scale 1:20

Detail Design

25° ceiling pitch

COS 2,864 approx

Provide 90 x 45

880 x 100 x 6mm steel top plate for fixing to ceiling

R20 plain rod at

150c/c welded

to 50 x 50 SHS

3 x 14g x 50mm type 17 batten screws. Allow for


fixing


90x45 H3.2 blockingunder floor for solid


Scale 1:20

Hut Wood Burner Details

blocking for ceiling fixings

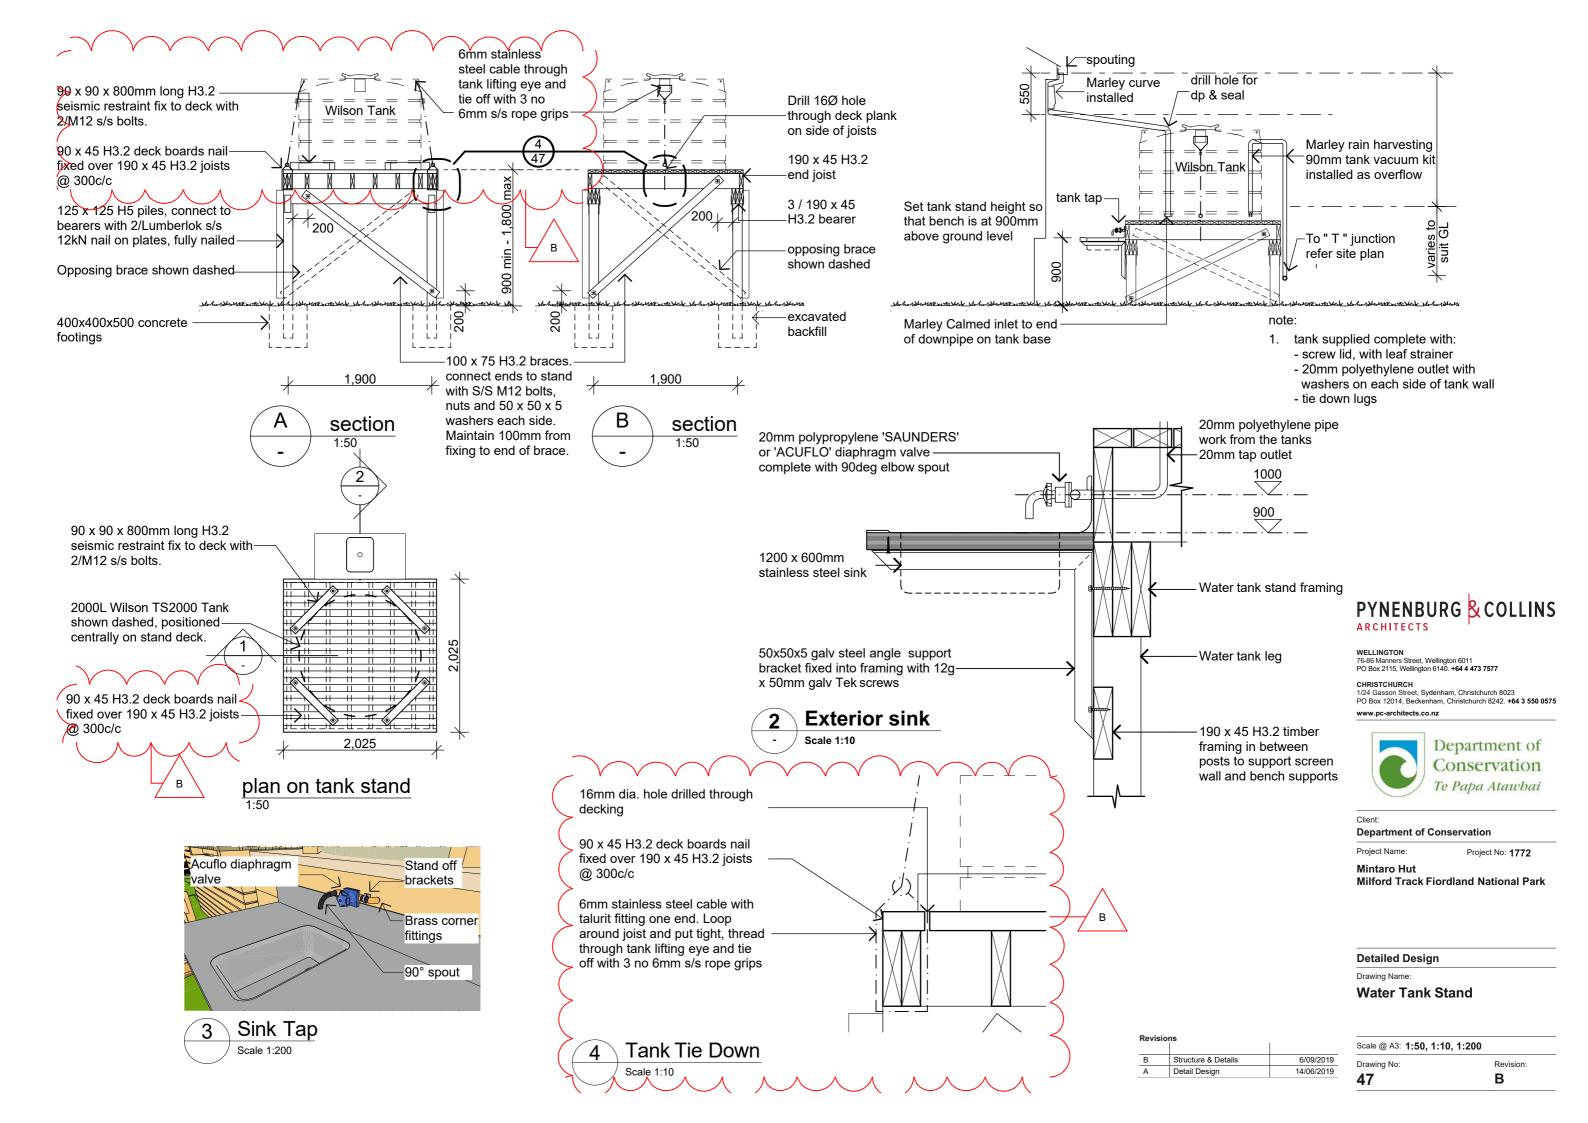

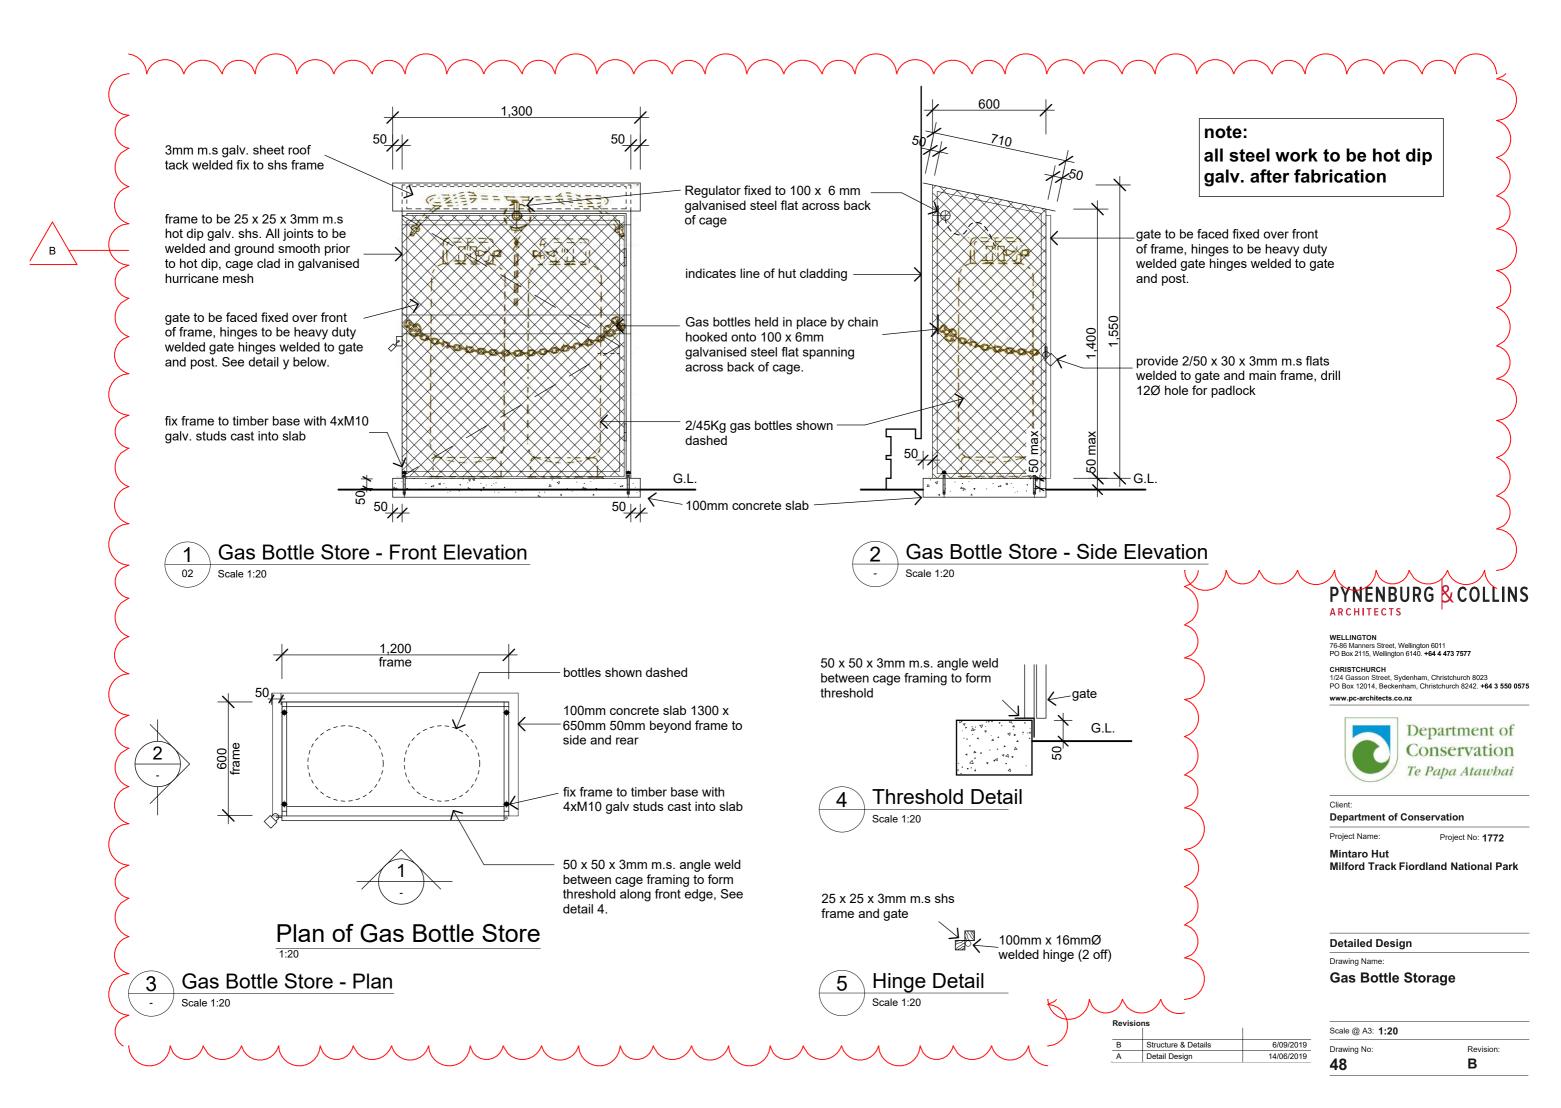

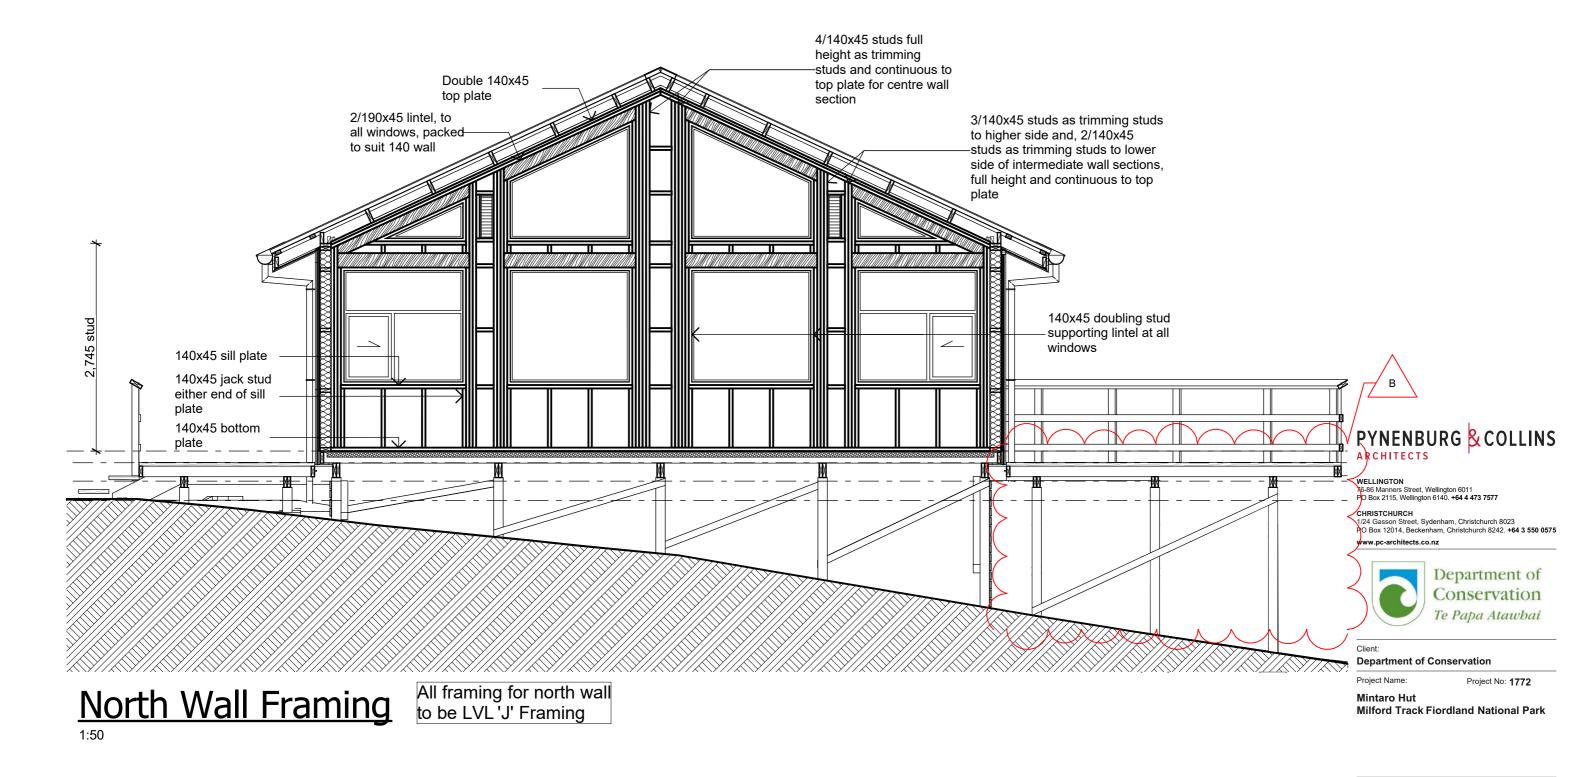

Revisions

 B
 Glulam Beam
 25/09/2019


 A
 Structure & Details
 6/09/2019

Scale @ A3: 1:50

Drawing No: Revision:
49 B

Detailed Design
Drawing Name:

North Wall Framing

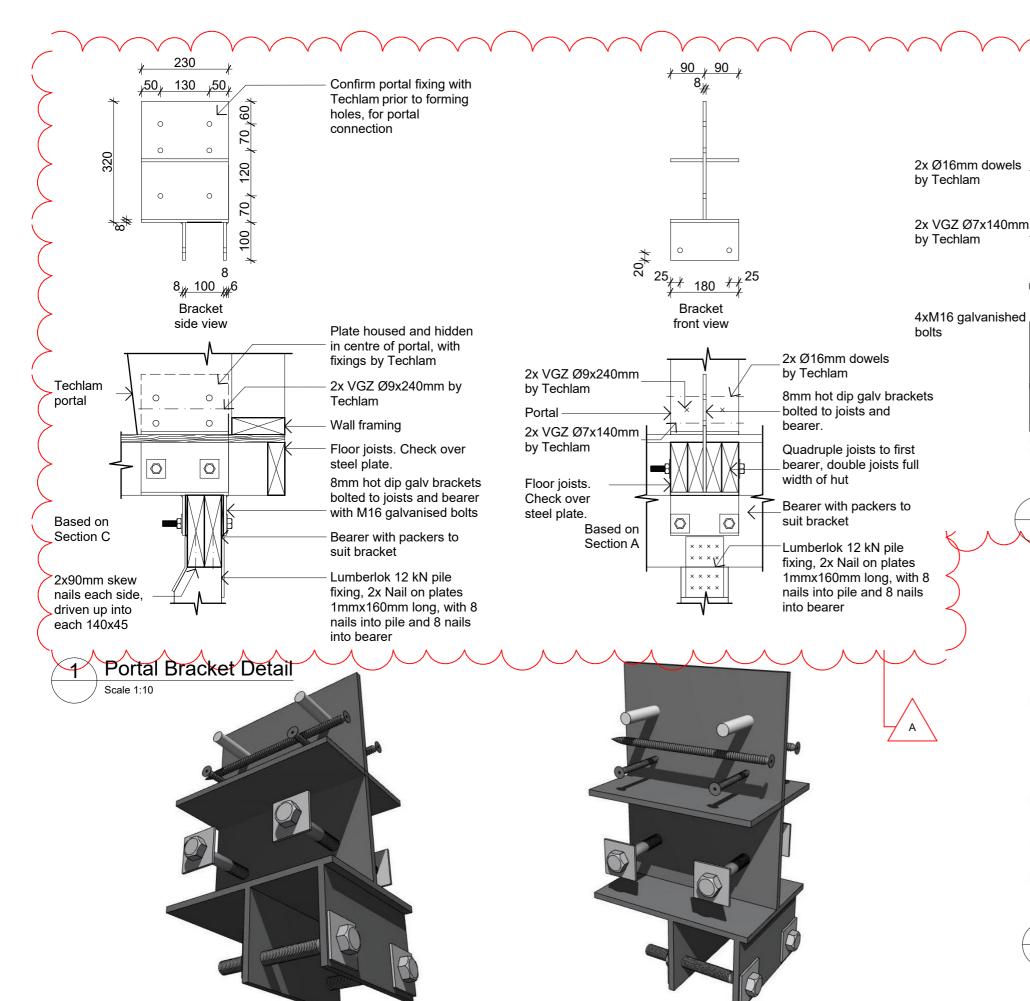

Portal Bracket 4

Portal Bracket 3

Material Notes:

COLORCOTE Zinacore Dimond Solar Rib roofing over SISALATION SUREWRAP roofing underlay over 70 x 45 H3.2 purlins on flat @ 800c/c max. evenly spaced, with end purlins @ 500mm c/c. Refer specification for fixings of roofing and purlins.

a2 COLORCOTE Zinacore Dimond Solar Rib roofing over SISALATION SUREWRAP roofing underlay over 190 x 45 H3.2 purlins on edge @ 900c/c max. evenly spaced, with end purlins @ 500mm c/c. Refer specification for fixings of roofing and

COLORCOTE Zinacore 0.40 BMT CORRUGATE PROFILE cladding over cavity battens over Sisalation SureWrap wall underlay over 4.5mm HomeRAB Pre-Cladding board system over timber framing

CHH 9mm ECOPLY BD grade untreated ceiling lining over 70 x 35 H1.2 battens @

CHH 9mm ECOPLY BD grade untreated wall lining with 10mm gap to flooring.

CHH 19mm ECOPLY CD grade H3.2 CCA 2400x1200 LS flooring over timber joists. Refer to foundation plan for sub floor framing

150x50 rough sawn H3.2 Radiata with top edges arised with webforge insert at doors Tensar SS20 Geogrid over exterior decking, fixed with stainless steel staples

4.5mm Hardiflex with PVC jointers

CHH 9mm Ecoply BD grade untreated ply over 1 layer 10mm Gib Fyreline, with ply finished with Fireshield IFR clear intumescent coating

 $h2^{\rm CHH\;9mm\;Ecoply\;BD\;grade\;untreated\;ply}_{\rm over\;1\;layers\;16mm\;Gib\;Fyreline,\;with\;ply}$ finished with Fireshield IFR clear intumescent coating

1 layer 16mm Gib Fyreline

PYNENBURG & COLLINS **ARCHITECTS**

WELLINGTON

Portal Bracket 1

Portal Bracket 2

Structure & Details

76-86 Manners Street, Wellington 6011 PO Box 2115, Wellington 6140. **+64 4 473 7577**

CHRISTCHURCH
1/24 Gasson Street, Sydenham, Christchurch 8023
PO Box 12014, Beckenham, Christchurch 8242. +64 3 550 0575 www.pc-architects.co.nz



Department of Conservation

Project Name: Project No: 1772

Mintaro Hut

Milford Track Fiordland National Park

Detailed Design

Drawing Name:


50

Portal Bracket

Scale @ A3: 1:10, 1:114.9242

Drawing No:

Revision Α

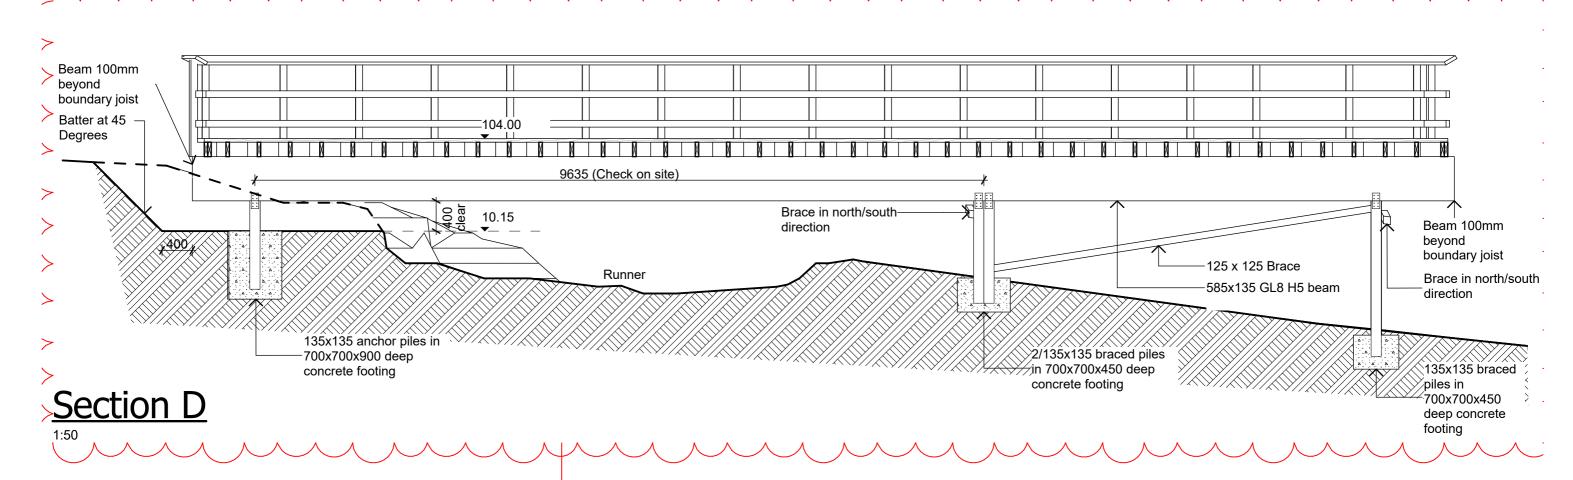



Pile/Beam connection to be lumberlok 12kN pile fixing. 2 x Nail on plates 1mm x 160mm long each side, with 8 nails into piles and 8 nails into bearer. 2 x 90mm skew nails each side in line of beam, driven up into beam.



PYNENBURG & COLLINS ARCHITECTS

WELLINGTON 76-86 Manners Street, Wellington 6011 PO Box 2115, Wellington 6140. +64 4 473 7577

CHRISTCHURCH
1/24 Gasson Street, Sydenham, Christchurch 8023
PO Box 12014, Beckenham, Christchurch 8242. +64 3 550 0575 www.pc-architects.co.nz



Department of Conservation

Project Name:

Project No: 1772

Mintaro Hut

Wardens Quarters Milford Track Fiordland National Park

Detailed Design

Drawing Name:

North Deck Beam Elevation / Section

Revisions	
1	

В	Glulam Beam	25/09/2019
Α	Structure & Details	6/09/2019

Revision:
В



1772 Mintaro Hut - Cooking



1772 Mintaro Hut - Seating



Hut Corridor



Hut Bunkrooms

PYNENBURG & COLLINS
ARCHITECTS

WELLINGTON76-86 Manners Street, Wellington 6011
PO Box 2115, Wellington 6140. **+64 4 473 7577**

PO Box 2115, Wellington 6140. **+64 4 473 7577**CHRISTCHURCH

CHRISTCHURCH
1/24 Gasson Street, Sydenham, Christchurch 8023
PO Box 12014, Beckenham, Christchurch 8242. +64 3 550 0575
www.pc-architects.co.nz



Client:

Department of Conservation

Name: Project No: 17

Mintaro Hut

Milford Track Fiordland National Park

Detailed Design

Drawing Name:

3D Interiors

Revisions				
D	Glulam Beam	25/09/2019		
С	Detail Design	14/06/2019		
В	Developed Design	22/03/2019		

Scale @ A3:	
Drawing No:	Revision:
60	D



Hut North West



Hut North East



PYNENBURG & COLLINS
ARCHITECTS

WELLINGTON 76-86 Manners Street, Wellington 6011 PO Box 2115, Wellington 6140. +64 4 473 7577

CHRISTCHURCH
1/24 Gasson Street, Sydenham, Christchurch 8023
PO Box 12014, Beckenham, Christchurch 8242. +64 3 550 0575

www.pc-architects.co.nz



Department of Conservation

Project Name:

Project No: 1772

Mintaro Hut

Milford Track Fiordland National Park

Detailed Design

Drawing Name:

3D Exteriors

TC TISIONS			
	D	Glulam Beam	25/09/2019
	С	Detail Design	14/06/2019
	В	Developed Design	22/03/2019

Scale @ A3:	
Drawing No:	Revision:
61	D